CALL TO ARTISTS

Request for Qualifications (RFQ) Carroll Creek Park Public Art & Wayfinding Project

Submission Deadline: January 10, 2020

Opportunity

Downtown Frederick Partnership is seeking an artist/artist team to design, fabricate and install an artistic outdoor fencing/wayfinding installation for a site along Carroll Creek Park.

Project Goals

The goals of the Carroll Creek Park Public Art & Wayfinding Project are:

- Provide a visible, recognizable, welcoming gateway to Carroll Creek Park
- Extend the existing Wayfinding & Signage System to better identify Carroll Creek Park to visitors and locals alike
- Bring color and energy to the Park
- Add a lighting element to the gateway area
- Deter loitering on the planter walls
- Integrate CPTED (community policing through environmental design) principles into the installation design
- Create a design with the potential to be modified and installed in the future for another existing stone planter in Carroll Creek Park.

Site Location and Requirements

Carroll Creek Park is located within the heart of Downtown Frederick. This urban linear park spans 1.3 miles through historic Downtown Frederick, and is located one block south of the main intersection of Market and Patrick Streets. The park extends from Baker Park on the west to a planned regional park (yet to be built) to the east.

Several restaurants, pedestrian footbridges, public art, cultural institutions, public benches, a trellis, and an amphitheater invite visitors to stroll along the brick paths on either side of Carroll Creek. Both summer and winter festivities are planned around and in Carroll Creek to activate the area year round (e.g., outdoor concerts, movie nights, water lilies located in the creek during warmer weather and decorated/lighted sailboats in the colder weather).

The location for the art/wayfinding installation is on an existing stone planter located on the northeast corner of Market Street and Carroll Creek Park, directly in front of the trellis structure. There is opportunity at this site to provide a visible gateway to the Park. See **Figures 1 &2.**

The art/installation must incorporate the words "Carroll Creek Park" and consider the attached Wayfinding & Signage Program Construction Documentation Package (see **Attachment A**) in the design of the signage portion of the art/installation. It is expected that art/installation be made of metal or a similarly durable material to withstand outdoor conditions. The art/installation must include lighting for nighttime visibility. The art/Installation must be anchored as to avoid damage to the masonry wall.

Because a similar artistic fencing/wayfinding project is envisioned in the future for the existing stone planter bed located on the northwest corner of Market Street and Carroll Creek Park, the design should lend itself to being modified for such application.

Lighting must also be incorporated into the design for the installation to be visible during evening hours. Electrical access is located within the planter, but electrical work will be required and will be the responsibility of the chosen artist/artist team.

Project Eligibility

All professional Artists or Artist Teams living within 80 miles of Frederick County are welcome to apply. No travel compensation is available.

Budget

The Budget for the project is **\$27,000**. The Budget includes all associated costs for design, fabrication, shipment, fixtures, electrical work, installation, and any required site modifications.

Application Process

Interested Applicants should submit the following:

- 1. **Statement of Interest Letter**. Please state (500 words maximum) why you are interested in this project and how your experience and approach would benefit this Project. If applying as a Team, please describe the collaborative experience and approach.
- 2. **Resumé(s)**: Teams must include resumes of all artists applying, maximum 3 pages each.
- 3. **References:** Include at least three (3) art and/or design professionals who have detailed knowledge of the Artist/Team's work. References must include contact name, organization/affiliation, address, telephone number, and e-mail for each reference.
- 4. **Examples of Previous Work:** Include a maximum ten (10) JPEG images, minimum five (5) JPEG. Only one (1) image per JPEG, no composite images. Images descriptions should include artist's name, title of work, date, media, site, location, description of the work, and budget. Any supplemental information you would like to include (articles, reviews, etc.)

Applications must be **digitally submitted by 6:00 PM by January 10, 2020** to **carrollcreekgateway@gmail.com**. Please be sure all files are titled clearly with the applicant's name.

Selection Process

The Selection Committee (comprised of Downtown Frederick Partnership and City of Frederick Parks and Recreation representatives and art professionals) will review all applications and select up to three (3) Finalist Artists or Artist Teams. The Finalists will be invited to develop proposals for the site.

Finalists will be selected based on the following criteria:

- Aesthetic Excellence Quality of the work samples, originality and innovation.
- Artist Experience Experience in creating public art of similar scope and scale. Appropriateness
 of the artist's past work as it relates to this project.
- Understanding of the Project Based upon the Statement of Interest Letter.

Each Finalist will be invited to present to the Selection Committee and receive an honorarium of \$250. The Selection Committee reserves the right to not select any proposal. Finalists will be evaluated during the interview based upon the above criteria as well as the following:

- Concept/Design The proposals must be appropriate to the site and fulfill the project goals.
- **Feasibility** –The proposals must be able to be completed within the allotted Budget and within the time frame.

Anticipated Timeline

RFQ Posted/Applications Accepted: December 13, 2019

RFQ Application Deadline: January 10, 2020 (received by 6 PM)

Finalists Contacted: Week of January 13, 2020
Finalist Selection Process: Week of February 17, 2020
Artist Award Notification Week of February 24, 2020

Artist Contracting Phase: End of February 2020

Artwork Final Design Phase/Approval: March 2020 City Approval Process: April 2020

Artwork Installation Period: May-June 2020

Questions and Inquiries

All questions and inquiries must be in writing and directed to Susie Leong, Public Art Consultant, carrollcreekgateway@gmail.com or at 301-455-4487.

Figure 1: Side view of the planter from Market Street; trellis structure located behind the planter



Figure 2: Planter site looking towards Market Street



FREDERICK, MARYLAND
WAYFINDING & SIGNAGE PROGRAM
CONSTRUCTION DOCUMENTATION PACKAGE

17 December 2008

City of Frederick Frederick, MD

Project No. Y41.07961.000

UPDATE: October 21, 2019



The Widener Building
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Philadelphia, PA 19107
T 215.599.4407
F 215.636.9989
www.merjedesign.com

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Frederick, MD Wayfinding & Signage Program 19 January 2009 Y41-07961.000

SECTION 1 | Signage Drawings

A. Graphic Standards

Clearview Highway ABCDEFGHIJKLMNOPQRSTUVWXYZ abcdefghijklmnopqrstuvwxyz 1234567890 "!@#\$%^

Amongst the several mechanical Arts that have engaged my attention, there is no one which I have pursued with so much steadiness and pleasure, as that of Letter Founding.

Downtown	Downtown	Downtown
acceptable	NOT acceptable	NOT acceptable
123A	123A	123A
acceptable	NOT acceptable	NOT acceptable

SPECIFICATIONS

The FABRICATOR must submit a full alphabet of 1" letters and numerals.

All type shall be set exactly as specified. Substitutions will only be accepted, at the DESIGNER'S discretion, where they match the specified typeface in every detail. The FABRICATOR should be aware that different versions of typesetting equipment may not satisfactorily match specified type faces and in such instances will not be acceptable.

Sometimes the Foot mark is mistaken for an apostrophe and an inch mark is mistaken for quotations. Below are examples of correct and incorrect apostrophe's for each typeface.

CLEARVIEW HWY 2-W



This apostrophe is CORRECT.

PARK'S



his apostrophe is INCORRECT.

PARK'S

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merje	The Widener Building, Suite 1500 One South Penn Square Philadelphia, PA 19107 T 215.599.4407 F 215.636.9989	City of Frederick, MD Wayfinding & Signage Program
	www.merjedesign.com	PROJECT NO. Y41.07961.000
SUBCONSULTANT		SHEET TITLE
DATE 12/17/2008	DRAWN BY: GS/KG/KB	Typography
These drawings are meant for DESIGN INTENT ONLY and are not for construction. Contractor shall verify and be responsible for all dimensions and conditions of the job. Contractor shall be familiar with the site	REVISIONS	Specifications
and conditions it presents. This office must be noti- fied of any variations from the dimensions and condi- tions shown on this drawing. Shop drawings and		SHEET NO.
details must be submitted to this office for approval prior to proceeding with fabrication. All copy shall be proofread by client and legal requirements checked		A.1

Rawlinson Bold ABCDEFGHIJKLMNOPQRSTUVWXYZ abcdefghijklmnopqrstuvwxyz 1234567890 ''!@#\$%^

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JBCONSULTANT		SHEET TITLE
12/17/2008	DRAWN BY: GS/KG/KB	Typography
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d of any variations from the dimensions and condi- ns shown on this drawing. Shop drawings and		SHEET NO.
tails must be submitted to this office for approval or to proceeding with fabrication. All copy shall be		A.2

LETTERSPACING

Inconsistencies in Letter Spacing

TYPEFACE 1

Frederic

TYPEFACE 2



Corrected Letter Spacing

TYPEFACE 1

Frederic

TYPEFACE 2

Parkir

IMPORTANT: Individual spacing of each letter needs to be evaluated. See Examples Above.

Kern all Copy so that each character is optically centered between the center of each of the surrounding characters.

SIGN TEXT STANDARDS

COPY HEIGHT

When measuring copy height, measure only the height of the Capital letters to determine your overall copy height (shown in illustration below as "X") Some of the other letters have an extended height beyond the average height of the letters.



LINE SPACING

When measuring line spacing, always measure from the baseline of the topmost text line to the baseline of the text line below (shown as "X")

_, E _	jklH	_ baseline
E	jklH	_ baseline .

SPECIFICATIONS

Individual spacing of each letter needs to be evaluated. All copy shall be kerned so that each character is optically centered between the center of each of the surrounding characters.

NOTES

CLIENT / PROJECT ENVIRONMENTS & EXPERIENCES City of Frederick, MD The Widener Building, Suite 1500 Wayfinding & Signage One South Penn Square Program T 215.599.4407 F 215.636.9989 Y41.07961.000 SUBCONSULTANT SHEET TITLE GS/KG/KB 12/17/2008 Typography These drawings are meant for DESIGN INTENT ONLY **Specifications** and are not for construction. Contractor shall verify and be responsible for all dimensions and condition of the job. Contractor shall be familiar with the site and conditions it presents. This office must be notified of any variations from the dimensions and cond tions shown on this drawing. Shop drawings and details must be submitted to this office for approva **A.3** prior to proceeding with fabrication. All copy shall be proofread by client and legal requirements checked

Vehicular Directional

Districts

Historic Downtown

Subdistricts

Baker Park/ Bandshell

Carroll Creek Park

Downtown Shop/Dine

East St. Shop/Dine

Everedy Sq. & Shab Row

Market/Patrick Shops & Dine

Market Street Shops & Dine

Patrick Street Shops & Dine

Theater District

Arts & Cultural

Cultural Arts Center

Delaplaine Visual Arts Ctr.

Weinberg Ctr. for the Arts

Education

Hood College MD School for the Deaf

Government

Airport **Public Library** City Hall

County Courthouse

Fort Detrick

MARC Station

MD Aviation Division

Municipal Office Annex

Police Dept.

Post Office

School Admin. Offices

Winchester Hall

Historic & Tourism

Clusterd. Spires **Golf Course**

Fairgrounds

Francis Scott **Key Memorial**

Harry Grove Stadium

Hessian Barracks

Jug Bridge

Mount Olivet Cemetery

Museum of Frederick Hist.

Nat'l Museum Civil War Med.

Rose Hill **Manor Park**

Schifferstadt Arch. Museum

St. John's Cemetery

Visitor Center

Winery

Parking

Additional Parking

Carroll Creek Garage

Church Street Garage

Court Street Garage

Street Garage

Garage

Everedy Sq. Parking

Shab Row

Amphitheater

Baker Park

Band Shell

Carillon

City Hall

DPW/Parks & Recreation

Historic National Road

Laboring Sons Park

Market St. Shop/Dine

Memorial Park

Market/East Shop/Dine

Maryland Ensemble Theatre

Mullinix Park/Diggs Pool

Municipal Office Annex

Patrick St. Shop/Dine

St. John's Cemetery Tally Rec. Center

Public Library

Tennis Courts

The Dreaming Theater District

Third Street Park

Transit Cente

Trinity Chapel

Visitor Center

Winchester Hall

W. Patrick St. Public Garage

Tot Lot

Winery

Museum Frederick County Hist

Nat'l Museum Civil War Med.

Roger Brooke Taney House

Schifferstadt Arch. Museum

Maas Park

East St. Shop/Dine

Bus Turnaround

E. All Saints

South Street

Parking

W. Patrick Street Garage MARC Parking Pedestrian

Dr. John Tyler's Home Armory/Tally Rec. Center John Hanson House Barbara Fritchie House Baseball (Baker Park) Kemp Hall Carroll Creek Ampitheater Ramsey House Carroll Creek Park Trail Mansion Carroll Creek Public Garage Trinity Chapel Tyler Spite House Community Bridge Mural County Permits & Review **County Courthouse** Court Street Public Garage Court/Patrick Public Garages Delaplaine Visual Arts Cente Diggs Pool/Mullinex Park Downtown Shop/Dine

Evangelical Reformed Church Evangelical Lutheran Church Independent Fire Company

Walking Tour

William Tyler Page Birthplace

NOTES

SPECIFICATIONS

ALL TYPE SHALL BE SET EXACTLY AS SPECIFIED.

merje

tions shown on this drawing. Shop drawings and

prior to proceeding with fabrication. All copy shall be proofread by client and legal requirements checked

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City of Frederick, MD

Wayfinding & Signage

CLIENT / PROJECT

SHEET TITLE

SUBCONSULTANT

DRAWN BY: 12/17/2008 GS/KG/KB These drawings are meant for DESIGN INTENT ONLY and are not for construction. Contractor shall verify and be responsible for all dimensions and conditi of the job. Contractor shall be familiar with the site and conditions it presents. This office must be notified of any variations from the dimensions and con-

Word Breaks

SHEET NO.

A.4

Note: Not all destination names shown on this page are used in the initial wayfinding program.

Hospitals

Frederick Mem. Hospital

LOGO & GRAPHIC IMAGES


FREDERICK

MARYLAND

LOGO SYMBOL






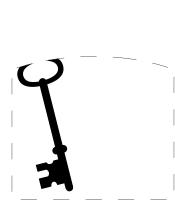

VDIR.1 PANEL GRAPHIC



VDIR.2 PANEL GRAPHIC

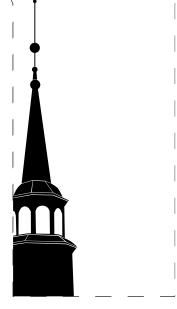

VDIR.3 PANEL GRAPHIC



DIST.3 BANNER GRAPHIC

SYMBOLS



HOSPITAL ICON

ARROWS





Left Arrow



Up-Left Arrow



Straight Arrow



Up-Right Arrow

MARYLAND



Right Arrow



Up-Straight-Left Arrow



Up-Straight-Right Arrow



SPECIFICATIONS

The FABRICATOR must submit one example of each symbol, logo and arrow.

All symbols, logos and arrows shall be set exactly as specified. Substitutions will only be accepted, at the DESIGNER'S discretion, where they match the specifications in every detail. The FABRICATOR should be aware that different versions of typesetting equipment may not satisfactorily match specified typefaces and in such instances will not be acceptable.

Guidelines and Logo Artwork are available in Illustrator EPS File Format.

USE of Arrows

When multiple directions are required on a sign, the following directional hierarchy shall take precedent. See Example below. Reference Message Schedule for individual Messages.



Straight Arrow





Right Arrow

NOTES

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Straight-Left Arrow

P1 White AKZO NOBEL Colormap-508B6 Surface painted, Grip-Gard Plu Polyurethane Clear Coat Protect Pantone: 154C Surface painted, Grip-Gard Plu Polyurethane Clear Coat Protect Pantone: 154C Surface painted, Grip-Gard Plu Polyurethane Clear Coat Protect P3 OPEN AKZO NOBEL Colormap-470-G5 Surface painted, Grip-Gard Plu P6 P6 Dark Blue AKZO NOBEL Colormap-470-G5 P6 Dark Blue AKZO NOBEL Colormap-470-H1 P6 Surface painted, Grip-Gard Plu P6 P7 Yellow Gold AKZO NOBEL Colormap-470-H1 P6 Surface painted, Grip-Gard Plu P6 P7 P7 P6 Surface P6 Surface P6 P7 P7 P6 Surface P6 Surface P6 P7 P7	us - Finish Semi-Gloss ectant us - Finish Semi-Gloss ectant us - Finish Semi-Gloss ectant us - Finish Semi-Gloss
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P4 OPEN Blue AKZO NOBEL Colormap-470-G5 Surface painted, Grip-Gard Plu Polyurethane Clear Coat Protect P6 Dark Blue AKZO NOBEL Colormap-470-H1 Surface painted, Grip-Gard Plu Pantone: 5463C Yellow Gold AKZO NOBEL Colormap-421-E4 Pantone: 1245C Surface painted, Grip-Gard Plu Polyurethane Clear Coat Protect AKZO NOBEL Colormap-421-E4 Polyurethane Clear Coat Protect ODEN	ectant us - Finish Semi-Gloss
P5 Blue AKZO NOBEL Colormap-470-G5 Pantone: 3035C Surface painted, Grip-Gard Plu Polyurethane Clear Coat Protect P6 Dark Blue AKZO NOBEL Colormap-470-H1 Surface painted, Grip-Gard Plu Pantone: 5463C Surface painted, Grip-Gard Plu Polyurethane Clear Coat Protect P7 Yellow Gold AKZO NOBEL Colormap-421-E4 Pantone: 1245C Surface painted, Grip-Gard Plu Polyurethane Clear Coat Protect	ectant us - Finish Semi-Gloss
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Pantone: 1245C Polyurethane Clear Coat Protect	ectant
P8 OPEN	
Pg Black AKZO NOBEL Surface painted, Grip-Gard Plu Colormap-508C5 Surface painted, Grip-Gard Plu	
V VINYLS	
V1 White Reflective 3M High Intensity Reflective Sheeting White 3290 Standard Color	
V2 Dark Blue Reflective 3M High Intensity Reflective Sheeting Match: AKZO NOBEL Colormap-470-H1 Custom Color : Pantone: 5463C	;
V3 Green Reflective 3M High Intensity Reflective Sheeting Match: AKZO NOBEL Colormap-440-D6 Custom Color : Pantone: 391C	
Blue Reflective 3M High Intensity Reflective Sheeting Match: AKZO NOBEL Colormap-470-G5 Custom Color : Pantone: 3035C	;
Yellow Gold 3M High Intensity Reflective Sheeting Match: AKZO NOBEL Colormap-421-E4 Custom Color : Pantone: 1245C	;
D.O.T. Blue Reflective 3M High Intensity Reflective Sheeting Color: 3935 Standard Color To match DOT Standard for H tr	trailblazer signs
White Translucent White Translucent 3M Scotchcal Translucent Graphic Film Color: 3630-20 Standard Color Alternate: Akzo Nobel-Grip Flex	ex paint -sample for approval
V8 Green Translucent 3M Scotchcal Translucent Graphic Film Match: AKZO NOBEL Colormap-440-D6 Alternate: Akzo Nobel-Grip Flex	ex paint -sample for approval
V9 Blue Translucent 3M Scotchcal Translucent Graphic Film Match: AKZO NOBEL Colormap-470-G5 Alternate: Akzo Nobel-Grip Flex	
Yellow Gold Translucent 3M Scotchcal Translucent Graphic Film Match: AKZO NOBEL Colormap-421-E4 Custom Color : Pantone: 1245C Alternate: Akzo Nobel-Grip Flex	
V11 Dark Blue Opaque 3M Scotchcal Electrocut Graphic Film Match: AKZO NOBEL Colormap-470-H1 Custom Color : Pantone: 5463C	:
V12 White Opaque 3M Scotchcal Translucent Graphic Film Color: White 180C-10 Standard Color	
V13 Blue Opaque 3M Scotchcal Electrocut Graphic Film Match: AKZO NOBEL Colormap-470-G5 Custom Color : Pantone: 3035C	:

SPECIFICATIONS

The FABRICATOR must submit 2 identical sets of each color specificed for approval prior to any painting. Sample swatches are to be produced on the substrate material of the final product.

The colors must look exactly the same every time they are used so that people associate them with the City of Frederick, MD. All media, vinyl, paint, and inks must be produced so that the colors match as specified on this page.

NOTES		
		OUTAIT / PRO JEST
ENVIRONMENTS &	EXPERIENCES	CLIENT / PROJECT
	The Widener Building, Suite 1500	City of Frederick, MD
merje	One South Penn Square Philadelphia, PA 19107	Wayfinding & Signage Program
	T 215.599.4407 F 215.636.9989	
	www.merjedesign.com	PROJECT NO. Y41.07961.000
SUBCONSULTANT		SHEET TITLE
DATE 12/17/2008	DRAWN BY: GS/KG/KB	-
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ons shown on this drawing. Shop drawings and etails must be submitted to this office for approval rior to proceeding with fabrication. All copy shall be		A.6
roofread by client and legal requirements checked y legal department.		A.O
×		

FREDERIO M MATE	CK COLORS RIALS	NAME	SPECIFICATION	PROCESS
M1		Brushed Aluminum	Horizontal Grain	Finish-Matte-Natural Polyurethane Clear Coat Protectant
M2		Stone	Match Existing Stone in Carroll Creek Park Streetscape	Consult Downtown Frederick Partnership and/or City of Frederick for specifications
M3		Brick	Match Existing Stone in Carroll Creek Park Streetscape	Consult Downtown Frederick Partnership and/or City of Frederick for specifications
I Inks				
11		Blue	Color Match: Pantone-309C	UV inks
12		Cream	Color Match: Pantone-7499C	UV inks
13		Orange(Brick)	Color Match: Pantone-154C	UV inks
14		Yellow Gold	Color Match: Pantone-7407C	UV inks

SPECIFICATIONS


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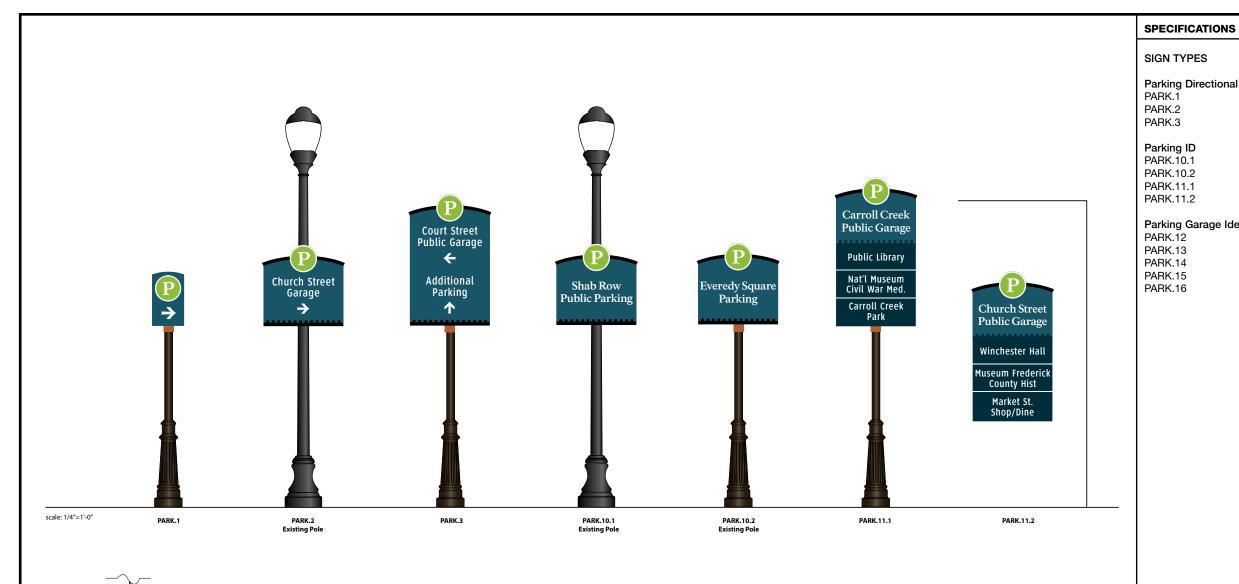
The colors must look exactly the same every time they are used so that people associate them with the City of Frederick, MD. All media, vinyl, paint, and inks must be produced so that the colors match as specified on this page.

- Fabricator to verify the mounting conditions and provide a detail drawing for each mounting situation, prior to fabrication.
 Fabricator must obtain approval from the Designer or Client for placement prior to fabrication.
- 2. Welds: All welds shall be ground smooth, paint all seams.
- 3. Hardware: All exposed hardware shall be tamper proof fasteners.
- 4. All exposed edges painted to match adjacent face.

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	www.merjedesign.com	PROJECT NO. Y41.07961.000
JBCONSULTANT		SHEET TITLE
12/17/2008	DRAWN BY: GS/KG/KB	
ate 12/17/2008 ase drawings are meant for DESIGN INTENT ONLY dare not for construction. Contractor shall verify at be responsible for all dimensions and conditions the job. Contractor shall be familiar with the site d conditions to presents. This office must be noti-	DRAWN BY: GS/KG/KB REVISIONS	Color Chart

B. Menu of Sign Types



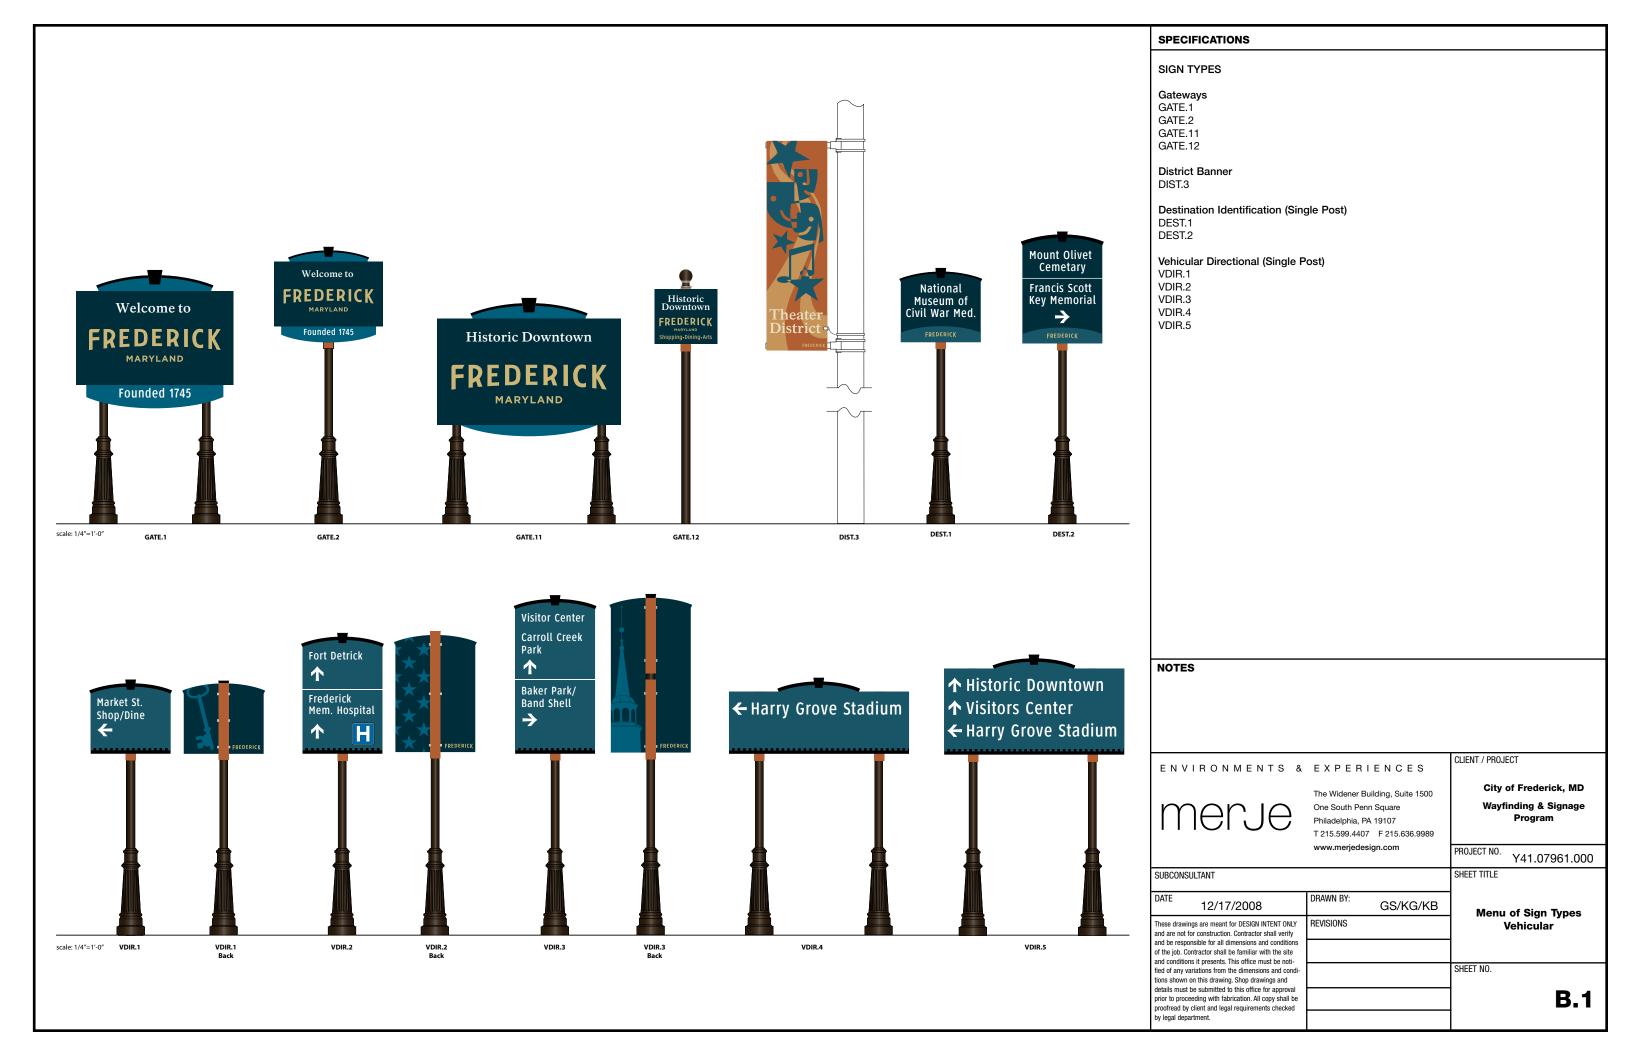



scale: 1/4"=1'-0"

PARK.12

Public Garage


PARK.25

↓ Entrance **↓**




PARK.16

PARK.15

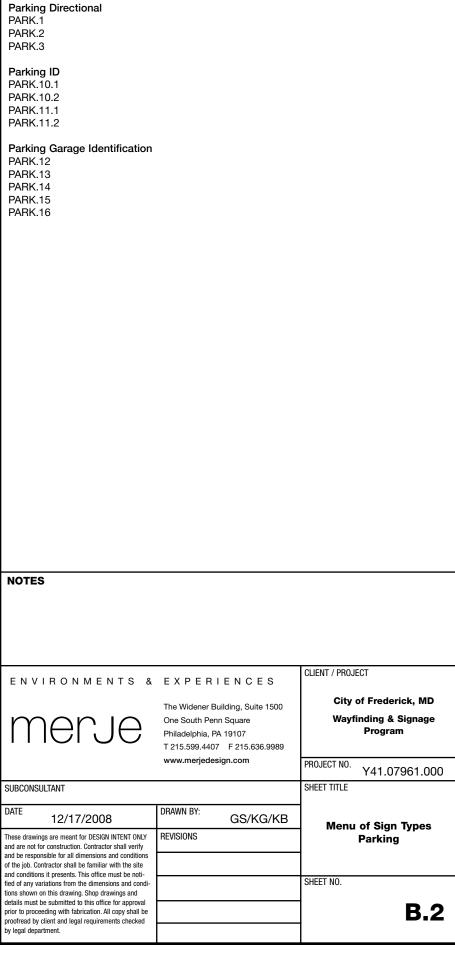



These drawings are meant for DESIGN INTENT ONLY and are not for construction. Contractor shall verify and be responsible for all dimensions and condition of the job. Contractor shall be familiar with the site and conditions it presents. This office must be notified of any variations from the dimensions and cond tions shown on this drawing. Shop drawings and

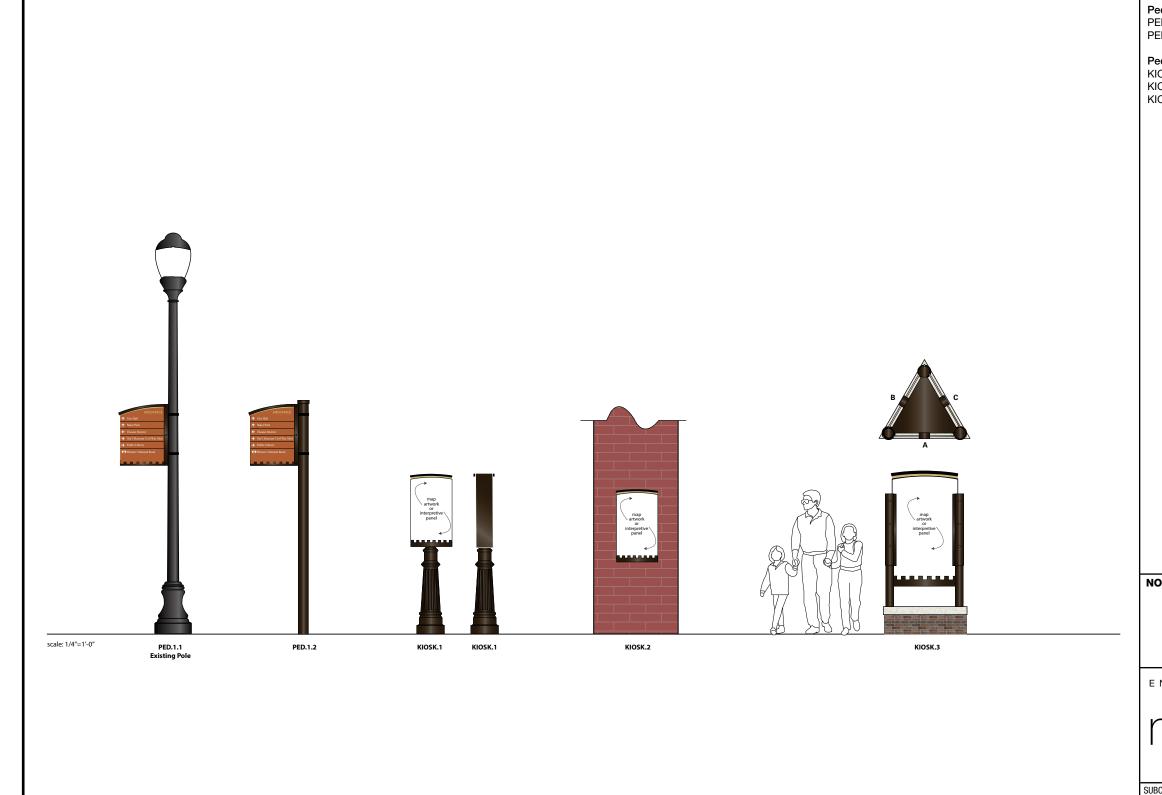

SPECIFICATIONS		
SIGN TYPES		
Pedestrian Directional PED.1.1 PED.1.2		
Pedestrian Kiosk KIOSK.1 KIOSK.2 KIOSK.3		
NOTES		
ENVIRONMENTS &	EXPERIENCES	CLIENT / PROJECT
merje	The Widener Building, Suite 1500 One South Penn Square Philadelphia, PA 19107 T 215.599.4407 F 215.636.9989	City of Frederick, MD Wayfinding & Signage Program
	www.merjedesign.com	PROJECT NO. Y41.07961.000
SUBCONSULTANT		SHEET TITLE
DATE 12/17/2008	DRAWN BY: GS/KG/KB	Menu of Sign Types
These drawings are meant for DESIGN INTENT ONLY and are not for construction. Contractor shall verify and be responsible for all dimensions and conditions	REVISIONS	Pedestrian
of the job. Contractor shall be familiar with the site and conditions it presents. This office must be noti-		CHEET NO
fied of any variations from the dimensions and condi- tions shown on this drawing. Shop drawings and details must be submitted to this office for approval		SHEET NO.
prior to proceeding with fabrication. All copy shall be proofread by client and legal requirements checked by legal department		B.3



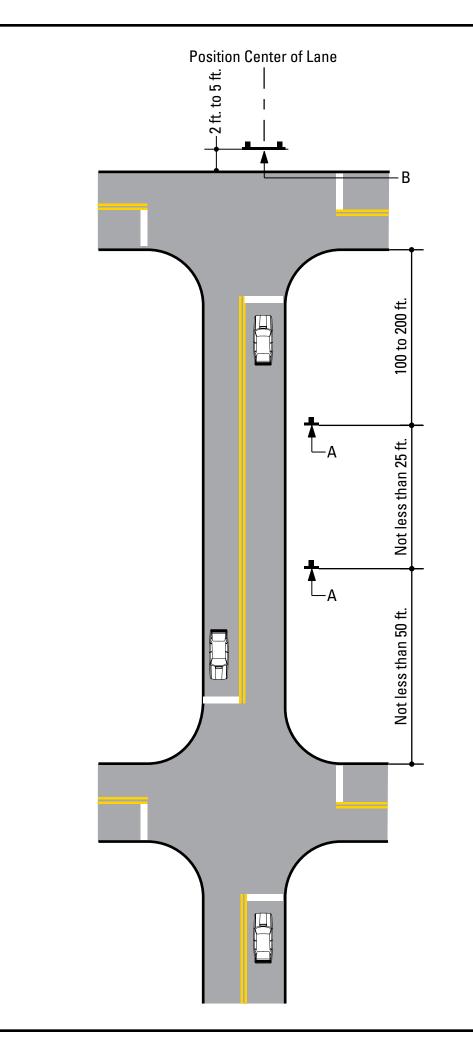

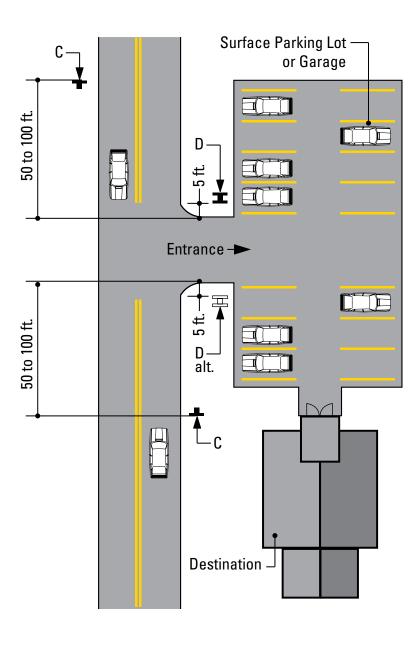

SPECIFICATIONS


FIGURE 1

Unless approved by the City of Frederick or its designated agent, all signs shall be installed to the right of the direction of traffic and where sufficient space is available.


- (a) Signs should be located to take advantage of natural terrain, to minimize impacts on scenic environment and to avoid visual conflicts with other signs, trees and lampposts within the City right-of-way.
- (b) Signs shall be located so as not to interfere with, obstruct or divert driver's attention from any other Official Traffic Control Device. Other Official Traffic Control Devices placed at intersection approaches, subsequent to the placement of a Wayfinding Sign, shall have precedence as to location and may require the relocation of the Wayfinding Sign. In the locations where Official Traffic Control Devices are integrated into the Wayfinding Signage System, the Official Traffic Control Devices shall take precedence with regard to order, space and location, over other information.
- (c) Wayfinding Signs should be positioned in such a manner that does not restrict driver's attention or view when making turns or driving through an intersection.
- (d) There should be a goal of one sign per block, although two are permissible, where necessary.


The following pages illustrate installation guidelines for the location and spacing of the various sign types. Figures 1-6 represent the guidelines for the location of the various sign types, while Figure 7 illustrates the lateral clearance guidelines.

ENVIRONMENTS &	EXPERIENCES	CLIENT / PROJECT
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	www.merjedesign.com	PROJECT NO. Y41.07961.000
SUBCONSULTANT		SHEET TITLE
DATE 12/17/2008	DRAWN BY: GS/KG/KB	Sign Placement
These drawings are meant for DESIGN INTENT ONLY and are not for construction. Contractor shall verify	REVISIONS	Guidelines
and be responsible for all dimensions and conditions of the job. Contractor shall be familiar with the site and conditions it presents. This office must be noti-		
fied of any variations from the dimensions and condi- tions shown on this drawing. Shop drawings and		SHEET NO.
details must be submitted to this office for approval prior to proceeding with fabrication. All copy shall be proofread by client and legal requirements checked		C.1
hy legal department		

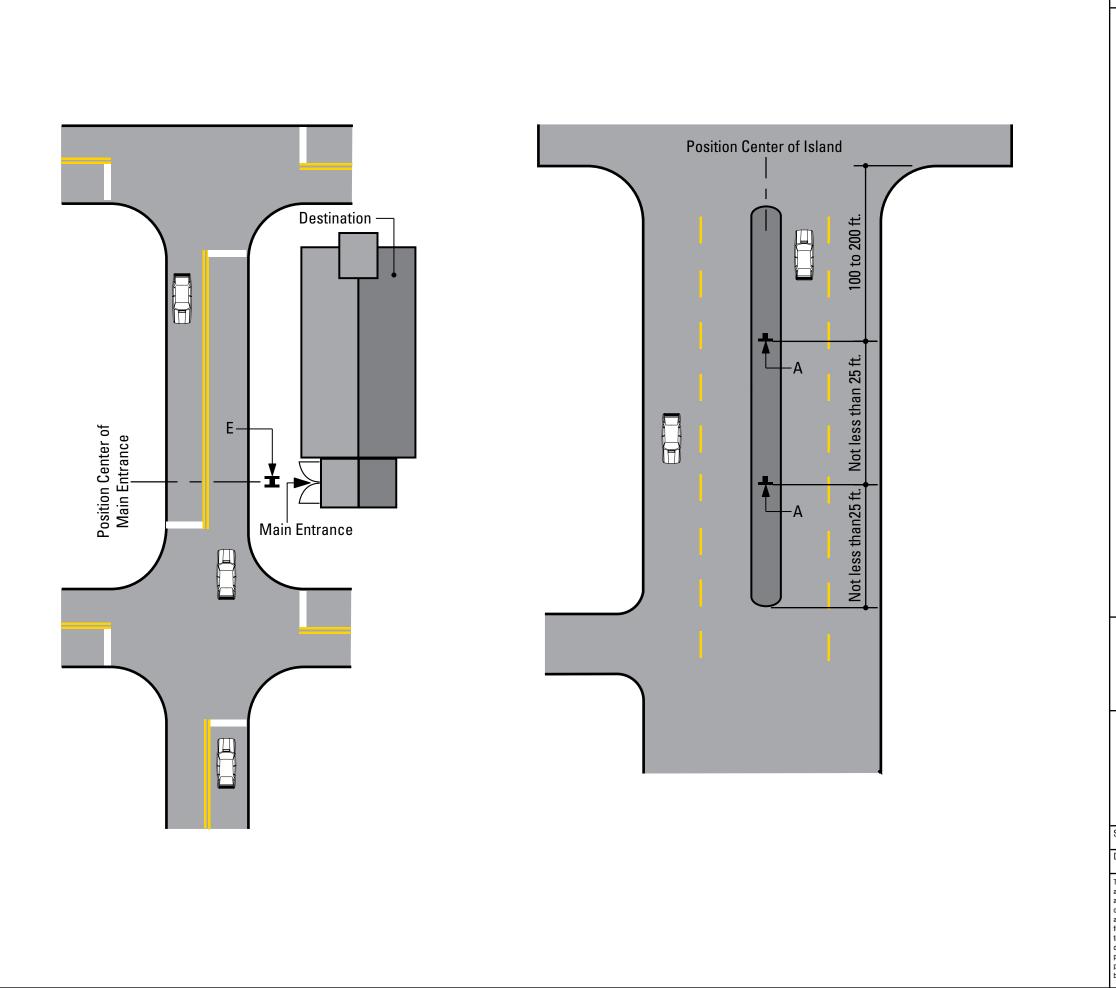


SPECIFICATIONS		
FIGURE 3 FIGURE 4		
NOTES		
ENVIRONMENTS &	EXPERIENCES	CLIENT / PROJECT
	The Widener Building, Suite 1500	City of Frederick, MD
merje	One South Penn Square Philadelphia, PA 19107 T 215.599.4407 F 215.636.9989	Wayfinding & Signage Program
	www.merjedesign.com	PROJECT NO. Y41.07961.000
SUBCONSULTANT DATE	DRAWN BY:	SHEET TITLE
12/17/2008 These drawings are meant for DESIGN INTENT ONLY	GS/KG/KB REVISIONS	. Sign Placement Guidelines
and are not for construction. Contractor shall verify ind be responsible for all dimensions and conditions if the job. Contractor shall be familiar with the site and conditions it presents. This office must be noti-		
ied of any variations from the dimensions and condi- ions shown on this drawing. Shop drawings and letails must be submitted to this office for approval		SHEET NO.
rior to proceeding with fabrication. All copy shall be roofread by client and legal requirements checked y legal department.		C.2

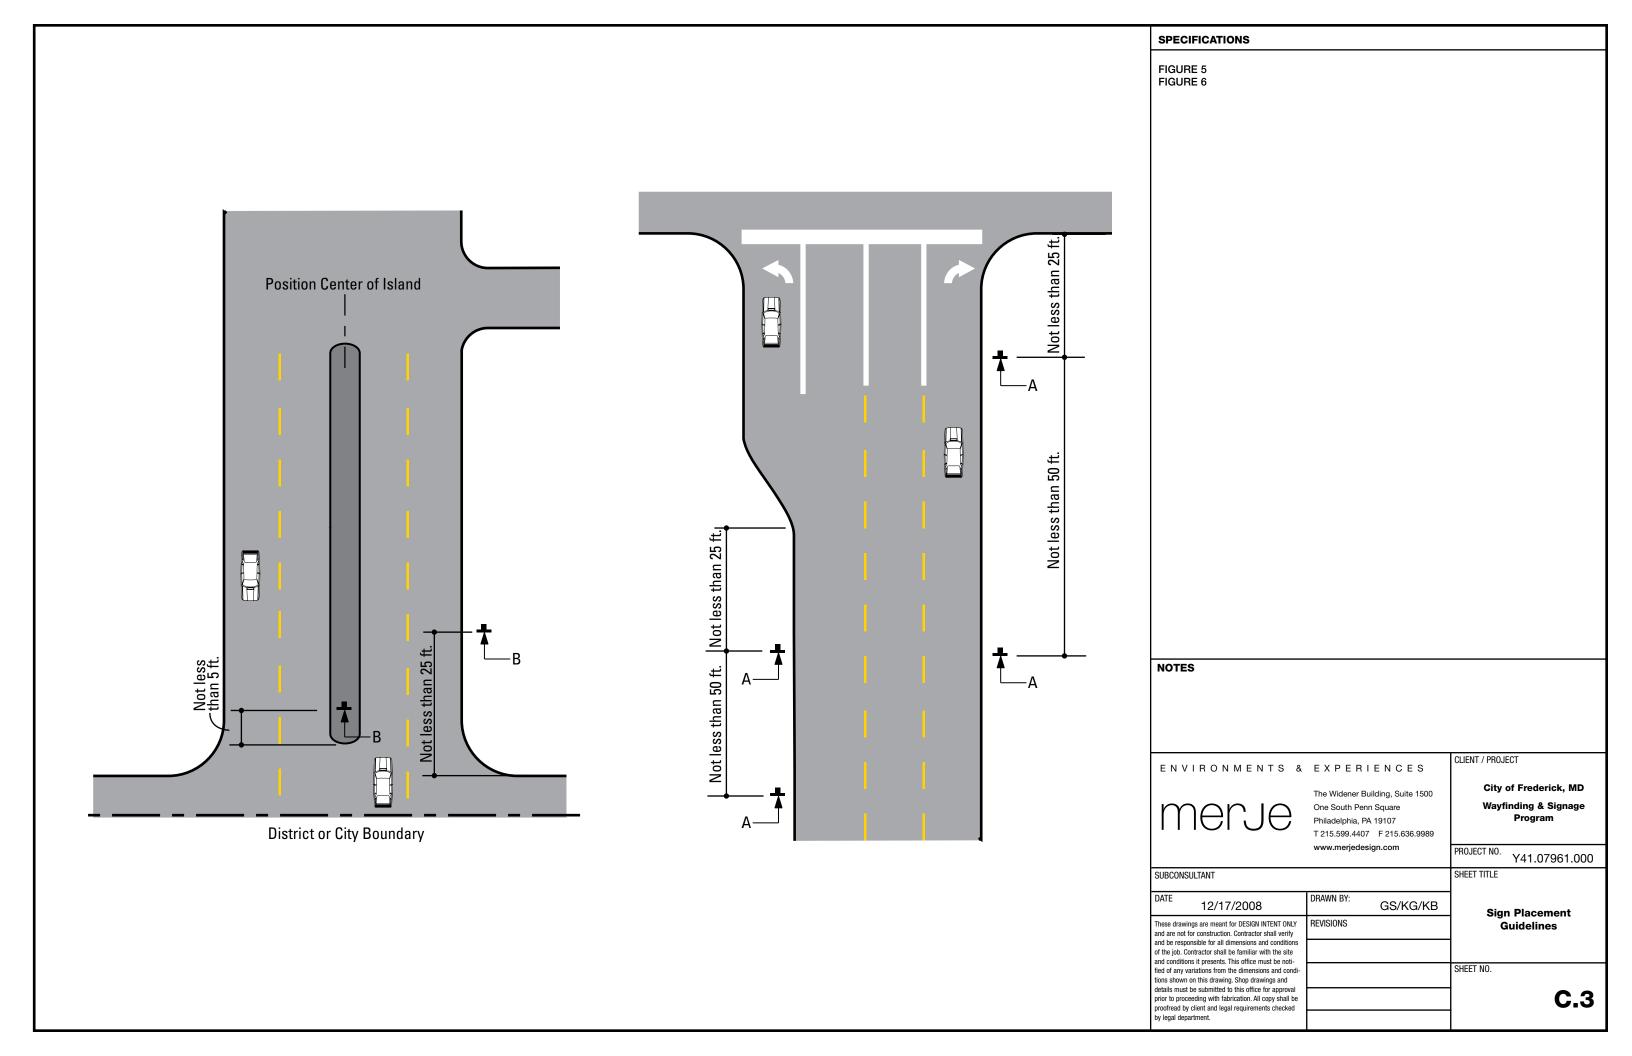


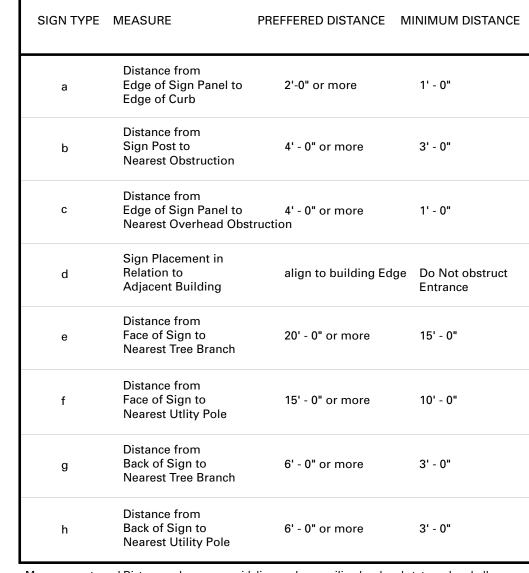


Measurements and Distances shown are guidelines only prevailing local and state codes shall supersede information presented.

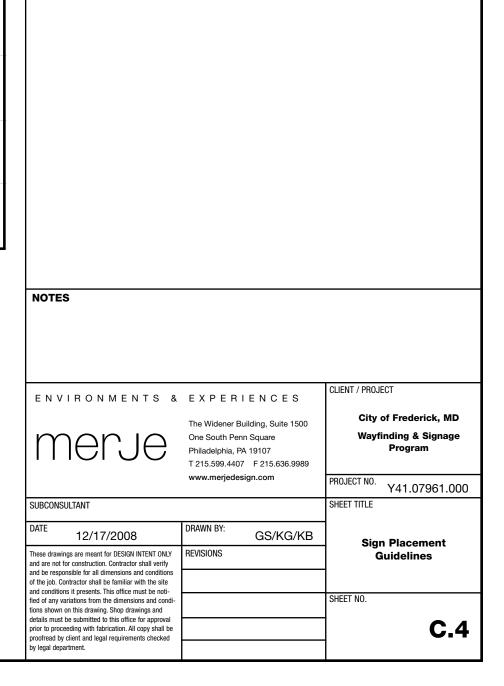

SPECIFICATIONS

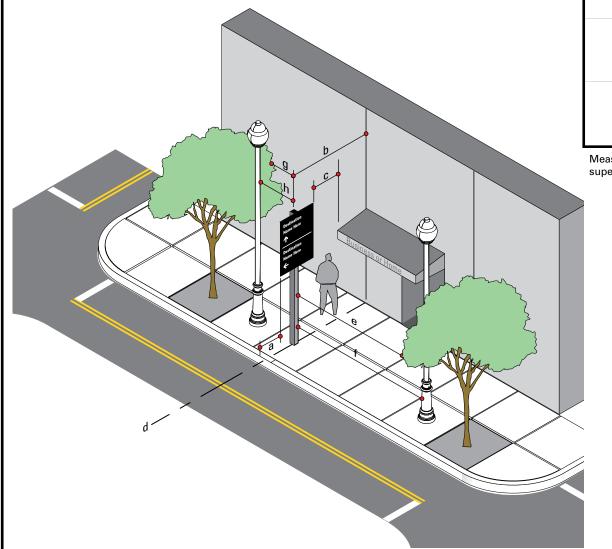

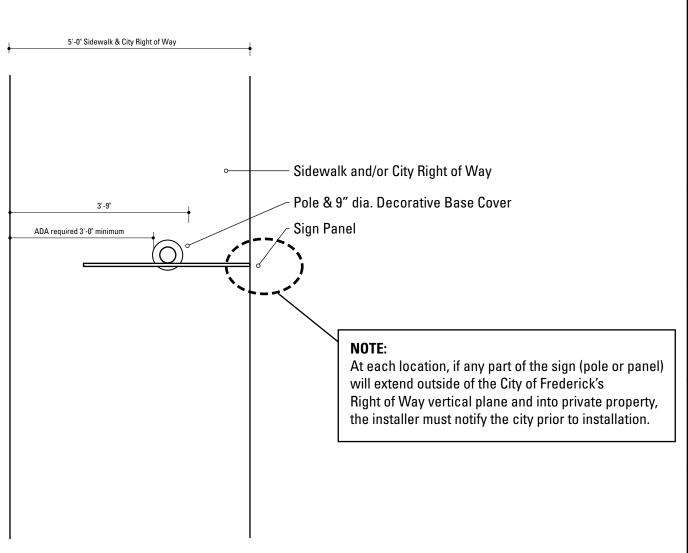

Reference View: 5 foot Sidewalk / City Right of Way

SCALE: 1/2" = 1'-0"

SIGN TYPE	DISTANCE EDGE OF CURB to EDGE OF SIGN PANEL	DISTANCE TO CENTER OF POST
DEST.1-2	2'-0"	3'-8 3/4"
DEST.1-2	1'-6"	3'-2 3/4"
DEST.1-2	1'-0"	2'-8 3/4"
GATE.2	2'-0"	4'-3"
GATE.2	1'-6"	3'-9"
GATE.2	1'-0"	3'-3"
GATE.12	2'-0"	3'-4"
GATE.12	1'-6"	2'-10"
GATE.12	1'-0"	2'-4"
PARK.1.2	2'-0"	2'-8"
PARK.1.2	1'-6"	2'-2"
PARK.1.2	1'-0"	1'-8"
PARK.2.2, PARK.3-4	2'-0"	3'-8 3/4"
PARK.2.2, PARK.3-4	1'-6"	3'-2 3/4"
PARK.2.2, PARK.3-4	1'-0"	2'-8 3/4"
PARK.10.2, PARK.11	.2 2'-0"	3'-8 3/4"
PARK.10.2, PARK.11	.2 1'-6"	3'-2 3/4"
PARK.10.2, PARK.11	.2 1'-0"	2'-8 3/4"
VDIR.1-3	2'-0"	3'-8 3/4"
VDIR.1-3	1'-6"	3'-2 3/4"
VDIR.1-3	1'-0"	2'-8 3/4"


NOTES

SPECIFICATIONS


- Fabricator to verify the mounting conditions and provide a detail drawing for each mounting situation, prior to fabrication.
 Fabricator must obtain approval from the Designer or Client for placement prior to fabrication.
- 2. Welds: All welds shall be ground smooth, paint all seams.
- 3. Hardware: All exposed hardware shall be tamper proof fasteners.
- 4. All exposed edges painted to match adjacent face.

ENVIRONMENTS &	EXPERIENCES	CLIENT / PROJECT
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	www.merjedesign.com	PROJECT NO. Y41.07961.000
SUBCONSULTANT		SHEET TITLE
DATE 12/17/2008	DRAWN BY: GS/KG/KB	Sign Placement
These drawings are meant for DESIGN INTENT ONLY and are not for construction. Contractor shall verify and be responsible for all dimensions and conditions of the job. Contractor shall be familiar with the site and conditions it presents. This office must be noti-	REVISIONS	Guidelines
and conduction it presents. This once thissis to indi- fied of any variations from the dimensions and condi- tions shown on this drawing. Shop drawings and details must be submitted to this office for approval prior to proceeding with fabrication. All copy shall be proofread by client and legal requirements checked by legal department.		SHEET NO.

D. Design Intent Drawings

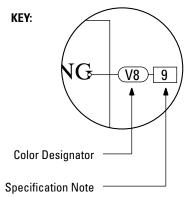

The Color Designator Chart is found in the Graphic Standards section A under "Colors". The Specification Notation is found on the same page as the drawings.

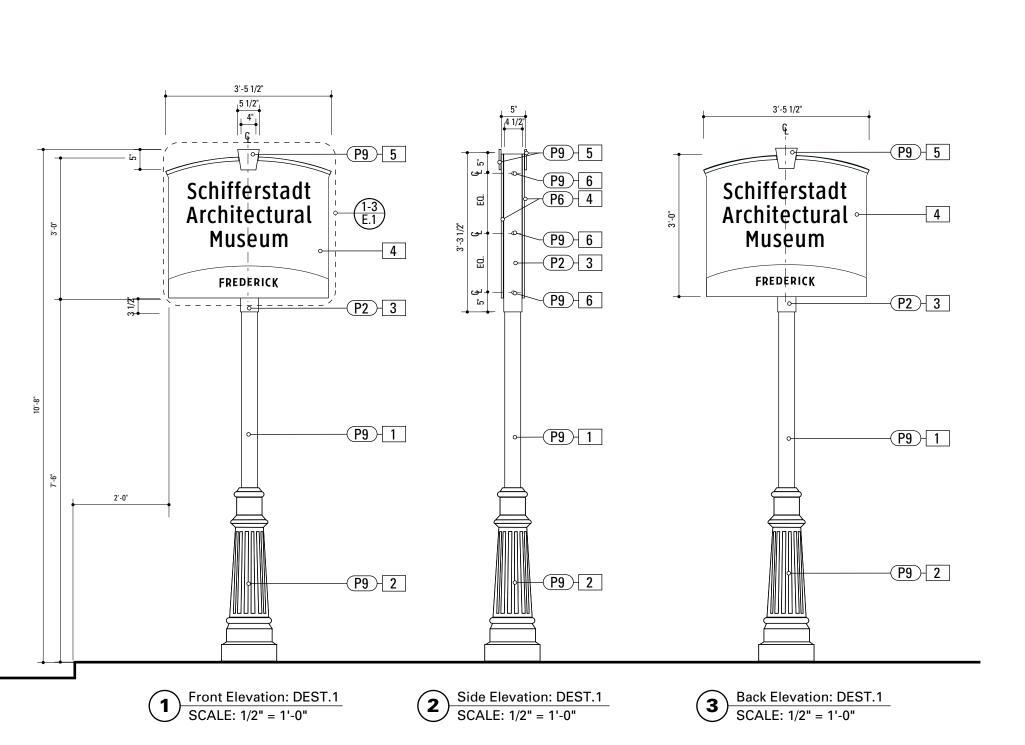

SPECIFICATIONS SIGN TYPE: DEST.1 FUNCTION: Arrival Sign

1. 4" ROUND POLE

MATERIAL: 4" dia, 1/4" thick Aluminum round tube FABRICATION PROCESS: Extruded / cut EDGES: Smooth COLOR: Custom, as noted SUFFACE PROCESS: Paint all exposed surfaces FOOTER: TRANSPO Break-safe or MDOT approved equal. REFER TO SECTION G FOR FOOTERS

2. DECORATIVE CLAMSHELL BASE

PRODUCT: Hapco Homewood Two-Piece Base (HOC), 4" butt diameter, 7 1/2" diameter base EDGES: Smooth COLOR: Custom, as noted SURFACE PROCESS: Paint all exposed surfaces FASTENER: Mechanically fastened around 4" pole

3. SLEEVE

MATERIAL: 1/4" thk Aluminum square tube FABRICATION PROCESS: Extruded / cut EDGES: Smooth COLOR: custom, as noted SURFACE PROCESS: Paint all exposed surfaces FASTENER: Mechanically fastened to pole

4. SIGN PANEL

MATERIAL: 1/4" thk Aluminum
FABRICATION PROCESS: Contour Cut
EDGES: Smooth
COLOR: custom, as noted
SURFACE PROCESS: Paint all exposed surfaces
FASTENER: Continuous weld to sleeve

Vinyl Graphics applied to front face of Sign Panel. See Color Page for Specifications


5. KEYSTONE


MATERIAL: 1/4" thk Aluminum
FABRICATION PROCESS: Contour Cut
EDGES: Smooth
COLOR: custom, as noted
SURFACE PROCESS: Paint all exposed surfaces
FASTENER: Chemical weld to sign panel

6. EXPOSED FASTENER

PRODUCT: Heavy Hex Head Bolt SIZE: As required MATERIAL: Stainless Steel FINISH: Painted COLOR: custom, as noted SURFACE PROCESS: Paint all exposed surfaces

- 1. Fabricator to verify the mounting conditions and provide a detail drawing for each mounting situation, prior to fabrication. Fabricator must obtain approval from the Designer or Client for placement prior to fabrication.
- 2. Welds: All welds shall be ground smooth, paint all seams.
- 3. Hardware: All exposed hardware shall be tamper proof fasteners.

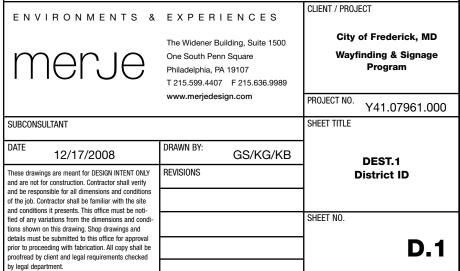

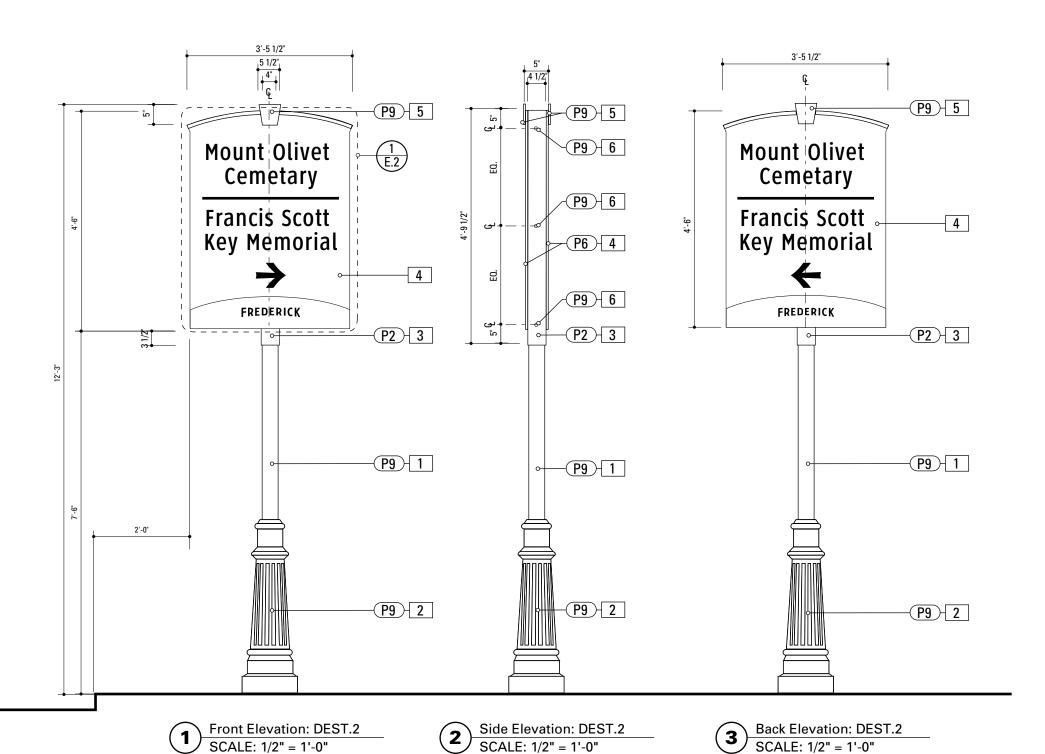

SPECIFICATIONS SIGN TYPE: DEST.2 FUNCTION: Arrival Sign & Directional

1. 4" ROUND POLE

MATERIAL: 4" dia, 1/4" thick Aluminum round tube FABRICATION PROCESS: Extruded / cut EDGES: Smooth COLOR: Custom, as noted SURFACE PROCESS: Paint all exposed surfaces FOOTER: TRANSPO Break-safe or MDOT approved equal. REFER TO SECTION G FOR FOOTERS

2. DECORATIVE CLAMSHELL BASE

PRODUCT: Hapco Homewood Two-Piece Base (HOC), 4" butt diameter, 7 1/2" diameter base FDGFS: Smooth COLOR: Custom, as noted SURFACE PROCESS: Paint all exposed surfaces FASTENER: Mechanically fastened around 4" pole

3. SLEEVE

MATERIAL: 1/4" thk Aluminum square tube FABRICATION PROCESS: Extruded / cut EDGES: Smooth COLOR: custom, as noted SURFACE PROCESS: Paint all exposed surfaces FASTENER: Mechanically fastened to pole

SIGN PANEL

MATERIAL: 1/4" thk Aluminum FABRICATION PROCESS: Contour Cut EDGES: Smooth COLOR: custom, as noted SURFACE PROCESS: Paint all exposed surfaces FASTENER: Continuous weld to sleeve

Vinyl Graphics applied to front face of Sign Panel. See Color Page for Specifications

KEYSTONE

MATERIAL: 1/4" thk Aluminum FABRICATION PROCESS: Contour Cut EDGES: Smooth COLOR: custom, as noted SURFACE PROCESS: Paint all exposed surfaces FASTENER: Chemical weld to sign panel

6. EXPOSED FASTENER

PRODUCT: Heavy Hex Head Bolt SIZE: As required MATERIAL: Stainless Steel FINISH: Painted COLOR: custom, as noted SURFACE PROCESS: Paint all exposed surfaces

- 1. Fabricator to verify the mounting conditions and provide a detail drawing for each mounting situation, prior to fabrication. Fabricator must obtain approval from the Designer or Client for placement prior to fabrication.
- 2. Welds: All welds shall be ground smooth, paint all seams
- 3. Hardware: All exposed hardware shall be tamper proof fasteners.
- 4. All exposed edges painted to match adjacent face.

and conditions it presents. This office must be noti-

fied of any variations from the dimensions and cond tions shown on this drawing. Shop drawings and details must be submitted to this office for approval

prior to proceeding with fabrication. All copy shall be proofread by client and legal requirements checked

by legal department.

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	www.merjedesign.com	PROJECT
JBCONSULTANT		SHEET TIT
12/17/2008	DRAWN BY: GS/KG/KB	
ese drawings are meant for DESIGN INTENT ONLY d are not for construction. Contractor shall verify d be responsible for all dimensions and conditions	REVISIONS	Desti


CLIENT / PROJECT

ity of Frederick, MD Vayfinding & Signage Program

Y41.07961.000

DEST.2 nation ID-Directional SHEET NO.

D.2

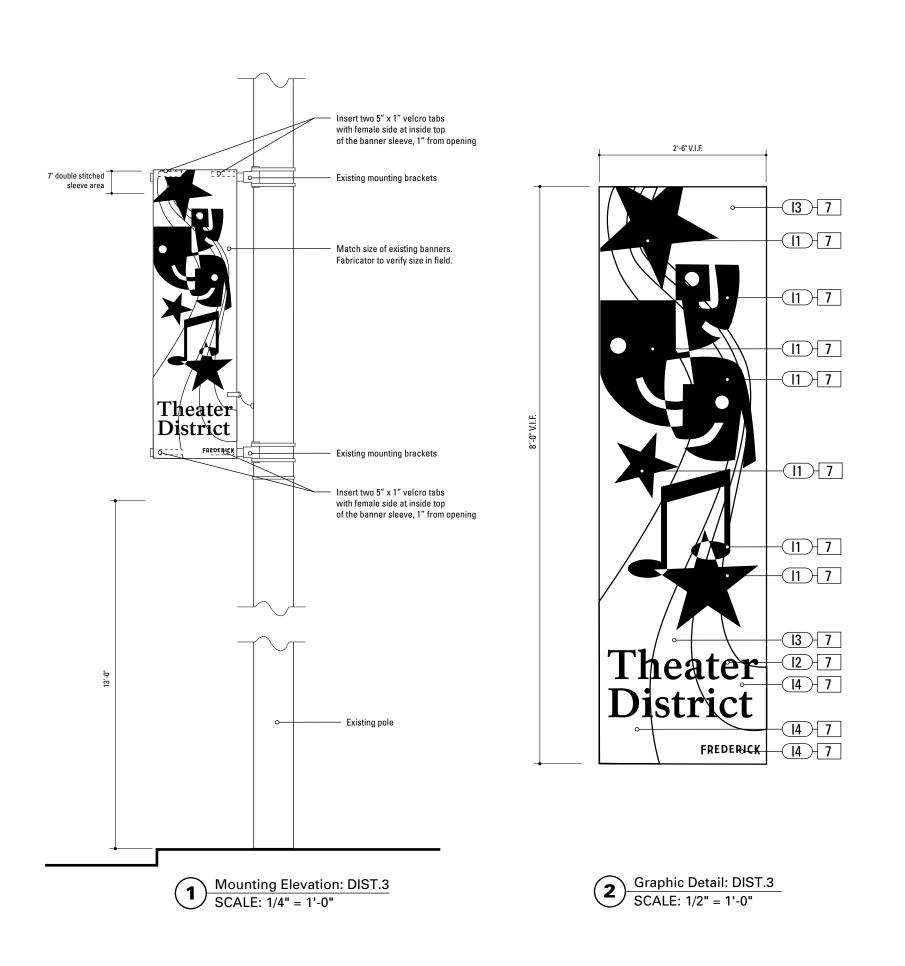

SPECIFICATIONS SIGN TYPE: DIST.3 FUNCTION: District ID Banner


7. BANNER

MATERIAL: Sunbrella Fabric / Fade-resistant nylon or approved equal PRINTING: Screenprinted with UV Resistant Ink FABRICATION: 2" pole pockets on top and bottom with 1" hem on each side, Insert two 5" x 1" velcro tabs with female side at inside top of the banner sleeve, 1" from opening COLOR: custom, as noted

NOTES

- 1. Fabricator to verify the mounting conditions and provide a detail drawing for each mounting situation, prior to fabrication. Fabricator must obtain approval from the Designer or Client for placement prior to fabrication.
- 2. Welds: All welds shall be ground smooth, paint all seams
- 3. Hardware: All exposed hardware shall be tamper proof fasteners.
- 4. All exposed edges painted to match adjacent face.

CLIENT / PROJECT ENVIRONMENTS & EXPERIENCES City of Frederick, MD The Widener Building, Suite 1500 Wayfinding & Signage One South Penn Square Philadelphia, PA 19107 Program T 215.599.4407 F 215.636.9989 www.merjedesign.com PROJECT NO. Y41.07961.000 SUBCONSULTANT SHEET TITLE DRAWN BY: 12/17/2008 GS/KG/KB DIST.3 REVISIONS These drawings are meant for DESIGN INTENT ONLY **District ID-Banner** and are not for construction. Contractor shall verify and be responsible for all dimensions and condition of the job. Contractor shall be familiar with the site and conditions it presents. This office must be noti-SHEET NO. fied of any variations from the dimensions and condi tions shown on this drawing. Shop drawings and details must be submitted to this office for approval **D.3** prior to proceeding with fabrication. All copy shall be proofread by client and legal requirements checked by legal department.

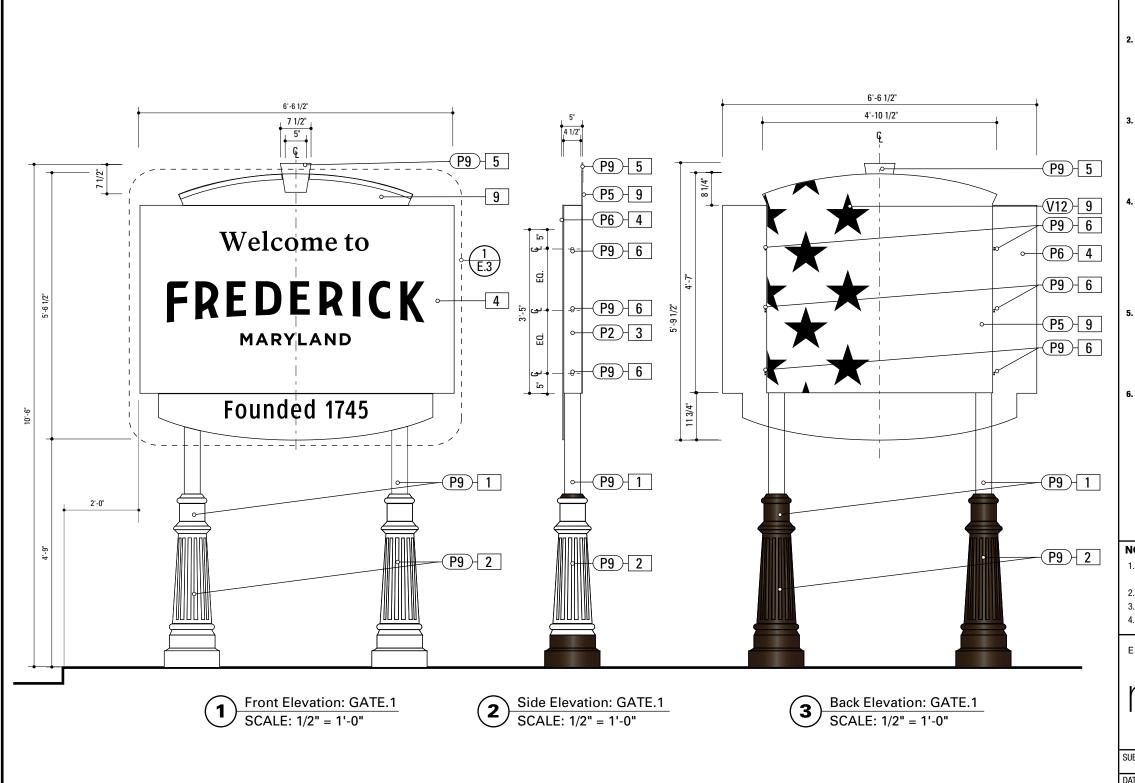

SPECIFICATIONS SIGN TYPE: GATE.1 FUNCTION: City Gateway

1. 4" ROUND POLE

MATERIAL: 4" dia, 1/4" thick Aluminum round tube FABRICATION PROCESS: Extruded / cut EDGES: Smooth COLOR: Custom, as noted SURFACE PROCESS: Paint all exposed surfaces FOOTER: TRANSPO Break-safe or MDOT approved equal. REFER TO SECTION G FOR FOOTERS

2. DECORATIVE CLAMSHELL BASE

PRODUCT: Hapco Homewood Two-Piece Base (HOC), 4" butt diameter, 7 1/2" diameter base EDGES: Smooth COLOR: Custom, as noted SURFACE PROCESS: Paint all exposed surfaces FASTENER: Mechanically fastened around 4" pole

3. SLEEVE

MATERIAL: 1/4" thk Aluminum square tube FABRICATION PROCESS: Extruded / cut EDGES: Smooth COLOR: custom, as noted SURFACE PROCESS: Paint all exposed surfaces FASTENER: Mechanically fastened to pole

4. SIGN PANEL

MATERIAL: 1/4" thk Aluminum
FABRICATION PROCESS: Contour Cut
EDGES: Smooth
COLOR: custom, as noted
SURFACE PROCESS: Paint all exposed surfaces
FASTENER: Continuous weld to sleeve

Vinyl Graphics applied to front face of Sign Panel. See Color Page for Specifications

5. KEYSTONE


MATERIAL: 1/4" thk Aluminum
FABRICATION PROCESS: Contour Cut
EDGES: Smooth
COLOR: custom, as noted
SURFACE PROCESS: Paint all exposed surfaces
FASTENER: Chemical weld to sign panel

6. EXPOSED FASTENER

PRODUCT: Heavy Hex Head Bolt SIZE: As required MATERIAL: Stainless Steel FINISH: Painted COLOR: custom, as noted SURFACE PROCESS: Paint all exposed surfaces

- 1. Fabricator to verify the mounting conditions and provide a detail drawing for each mounting situation, prior to fabrication. Fabricator must obtain approval from the Designer or Client for placement prior to fabrication.
- 2. Welds: All welds shall be ground smooth, paint all seams.
- 3. Hardware: All exposed hardware shall be tamper proof fasteners.
- 4. All exposed edges painted to match adjacent face.

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	www.merjedesign.com	PROJECT NO. Y41.07961.000
BCONSULTANT		SHEET TITLE
TE 12/17/2008	DRAWN BY: GS/KG/KB	GATE.1
se drawings are meant for DESIGN INTENT ONLY are not for construction. Contractor shall verify	REVISIONS	City Gateway
be responsible for all dimensions and conditions he job. Contractor shall be familiar with the site conditions it presents. This office must be noti-		
I of any variations from the dimensions and condi- is shown on this drawing. Shop drawings and		SHEET NO.
ails must be submitted to this office for approval or to proceeding with fabrication. All copy shall be ofread by client and legal requirements checked		D.4

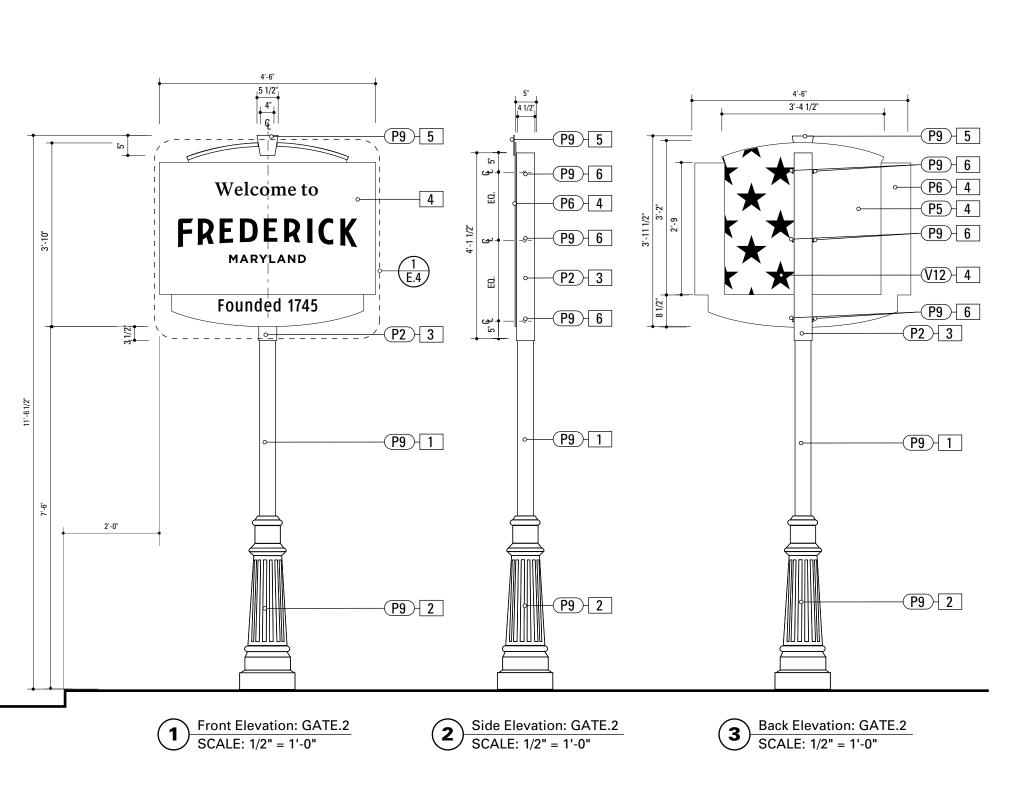

SPECIFICATIONS SIGN TYPE: GATE.2 FUNCTION: City Gateway

1. 4" ROUND POLE

MATERIAL: 4" dia, 1/4" thick Aluminum round tube FABRICATION PROCESS: Extruded / cut EDGES: Smooth COLOR: Custom, as noted SURFACE PROCESS: Paint all exposed surfaces FOOTER: TRANSPO Break-safe or MDOT approved equal. REFER TO SECTION G FOR FOOTERS

2. DECORATIVE CLAMSHELL BASE

PRODUCT: Hapco Homewood Two-Piece Base (HOC), 4" butt diameter, 7 1/2" diameter base EDGES: Smooth COLOR: Custom, as noted SURFACE PROCESS: Paint all exposed surfaces FASTENER: Mechanically fastened around 4" pole

3. SLEEVE

MATERIAL: 1/4" thk Aluminum square tube FABRICATION PROCESS: Extruded / cut EDGES: Smooth COLOR: custom, as noted SURFACE PROCESS: Paint all exposed surfaces FASTENER: Mechanically fastened to pole

4. SIGN PANEL

MATERIAL: 1/4" thk Aluminum
FABRICATION PROCESS: Contour Cut
EDGES: Smooth
COLOR: custom, as noted
SURFACE PROCESS: Paint all exposed surfaces
FASTENER: Continuous weld to sleeve

Vinyl Graphics applied to front face of Sign Panel. See Color Page for Specifications

5. KEYSTONE

MATERIAL: 1/4" thk Aluminum
FABRICATION PROCESS: Contour Cut
EDGES: Smooth
COLOR: custom, as noted
SURFACE PROCESS: Paint all exposed surfaces
FASTENER: Chemical weld to sign panel

6. EXPOSED FASTENER


PRODUCT: Heavy Hex Head Bolt SIZE: As required MATERIAL: Stainless Steel FINISH: Painted COLOR: custom, as noted SURFACE PROCESS: Paint all exposed surfaces

NOTES

by legal department.

- 1. Fabricator to verify the mounting conditions and provide a detail drawing for each mounting situation, prior to fabrication. Fabricator must obtain approval from the Designer or Client for placement prior to fabrication.
- 2. Welds: All welds shall be ground smooth, paint all seams
- 3. Hardware: All exposed hardware shall be tamper proof fasteners.
- 4. All exposed edges painted to match adjacent face.

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	www.merjedesign.com	PROJECT NO. Y41.07961.000
SUBCONSULTANT		SHEET TITLE
DATE 12/17/2008	DRAWN BY: GS/KG/KB	GATE.2
These drawings are meant for DESIGN INTENT ONLY and are not for construction. Contractor shall verify	REVISIONS	City Gateway
and be responsible for all dimensions and conditions of the job. Contractor shall be familiar with the site and conditions it presents. This office must be noti-		
fied of any variations from the dimensions and condi- tions shown on this drawing. Shop drawings and		SHEET NO.
details must be submitted to this office for approval prior to proceeding with fabrication. All copy shall be		D.5

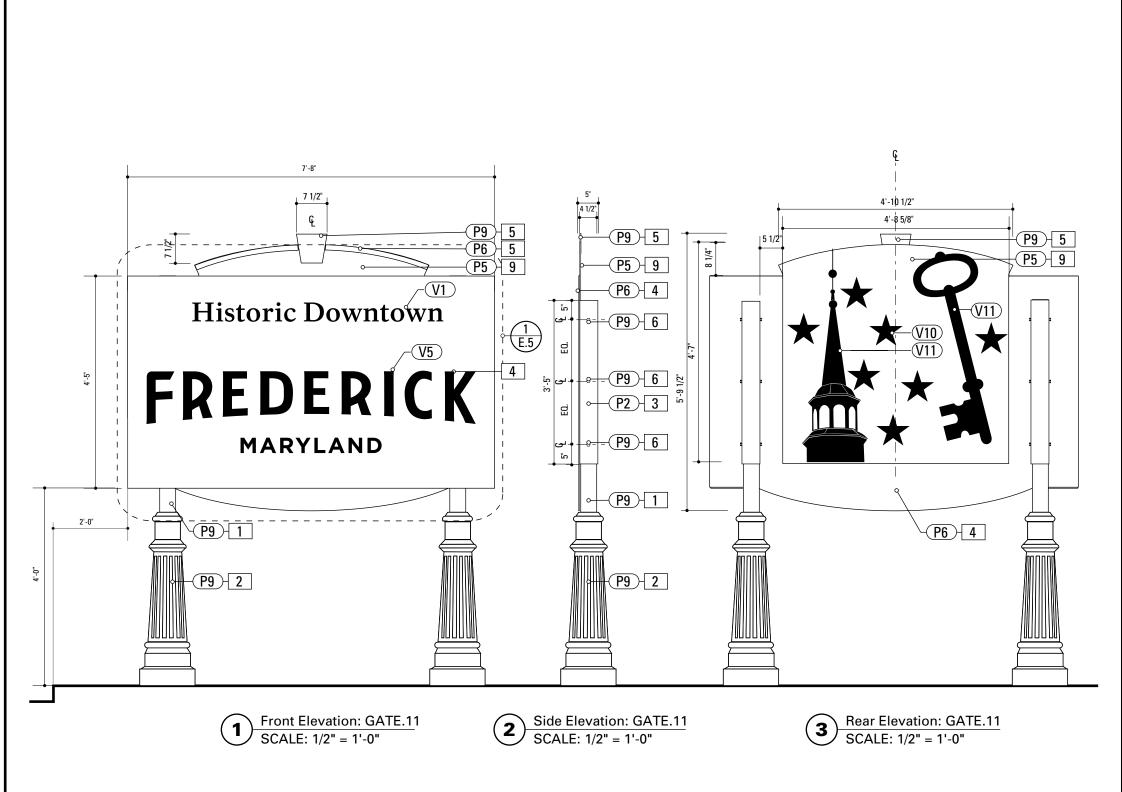

SPECIFICATIONS

SIGN TYPE: GATE.11 **FUNCTION:** District Gateway

1. 4" ROUND POLE

MATERIAL: 4" dia, 1/4" thick Aluminum round tube FABRICATION PROCESS: Extruded / cut EDGES: Smooth COLOR: Custom, as noted SURFACE PROCESS: Paint all exposed surfaces

FOOTER: TRANSPO Break-safe or MDOT approved equal.

REFER TO SECTION G FOR FOOTERS

2. DECORATIVE CLAMSHELL BASE
PRODUCT: Hapco Homewood Two-Piece Base (HOC), 4" butt
diameter, 7 1/2" diameter base
EDGES: Smooth
COLOR: Custom, as noted
SURFACE PROCESS: Paint all exposed surfaces
FASTENER: Mechanically fastened around 4" pole

3. SLEEVE

MATERIAL: 1/4" thk Aluminum square tube FABRICATION PROCESS: Extruded / cut EDGES: Smooth COLOR: custom, as noted SURFACE PROCESS: Paint all exposed surfaces FASTENER: Mechanically fastened to pole

4. SIGN PANEL

MATERIAL: 1/4" thk Aluminum FABRICATION PROCESS: Contour Cut EDGES: Smooth COLOR: custom, as noted SURFACE PROCESS: Paint all exposed surfaces FASTENER: Continuous weld to sleeve

Vinyl Graphics applied to front face of Sign Panel. See Color Page for Specifications


5. KEYSTONE


MATERIAL: 1/4" thk Aluminum
FABRICATION PROCESS: Contour Cut
EDGES: Smooth
COLOR: custom, as noted
SURFACE PROCESS: Paint all exposed surfaces
FASTENER: Chemical weld to sign panel

6. EXPOSED FASTENER

PRODUCT: Heavy Hex Head Bolt SIZE: As required MATERIAL: Stainless Steel FINISH: Painted COLOR: custom, as noted SURFACE PROCESS: Paint all exposed surfaces

- Fabricator to verify the mounting conditions and provide a detail drawing for each mounting situation, prior to fabrication.
 Fabricator must obtain approval from the Designer or Client for placement prior to fabrication.
- 2. Welds: All welds shall be ground smooth, paint all seams
- 3. Hardware: All exposed hardware shall be tamper proof fasteners.
- 4. All exposed edges painted to match adjacent face.

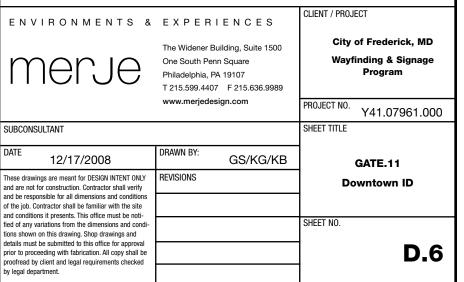

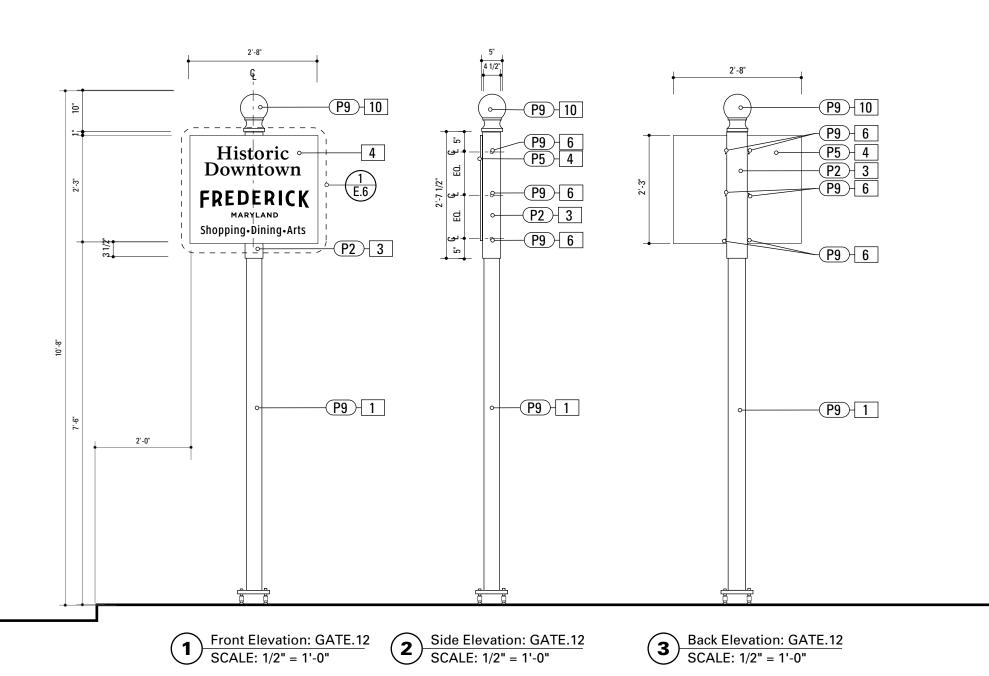

SPECIFICATIONS SIGN TYPE: GATE.12 **FUNCTION:** District Gateway

1. 4" ROUND POLE

MATERIAL: 4" dia, 1/4" thick Aluminum round tube FABRICATION PROCESS: Extruded / cut EDGES: Smooth COLOR: Custom, as noted SURFACE PROCESS: Paint all exposed surfaces FOOTER: TRANSPO Break-safe or MDOT approved equal. REFER TO SECTION G FOR FOOTERS

3. SLEEVE MATERIAL: 1/4" thk Aluminum square tube FABRICATION PROCESS: Extruded / cut EDGES: Smooth COLOR: custom, as noted SURFACE PROCESS: Paint all exposed surfaces FASTENER: Mechanically fastened to pole

4. SIGN PANEL

MATERIAL: 1/4" thk Aluminum FABRICATION PROCESS: Contour Cut EDGES: Smooth COLOR: custom, as noted SURFACE PROCESS: Paint all exposed surfaces FASTENER: Continuous weld to sleeve

Vinyl Graphics applied to front face of Sign Panel. See Color

Page for Specifications

6. EXPOSED FASTENER

PRODUCT: Heavy Hex Head Bolt SIZE: As required MATERIAL: Stainless Steel FINISH: Painted COLOR: custom, as noted SURFACE PROCESS: Paint all exposed surfaces


10. POLE CAP

PRODUCT: Holophane Small Post Cap, Finial BF or approved equal MATERIAL: Cast Aluminum EDGES: Smooth COLOR: Custom, as noted SURFACE PROCESS: Paint all exposed surfaces FASTENER: Mechanically fastened to 4" pole

by legal department.

- 1. Fabricator to verify the mounting conditions and provide a detail drawing for each mounting situation, prior to fabrication. Fabricator must obtain approval from the Designer or Client for placement prior to fabrication.
- 2. Welds: All welds shall be ground smooth, paint all seams.
- 3. Hardware: All exposed hardware shall be tamper proof fasteners.
- 4. All exposed edges painted to match adjacent face.

ENVIRONMENTS &	EXPERIENCES	CLIENT / PROJECT
merje	The Widener Building, Suite 1500 One South Penn Square Philadelphia, PA 19107 T 215.599.4407 F 215.636.9989	City of Frederick, MD Wayfinding & Signage Program
	www.merjedesign.com	PROJECT NO. Y41.07961.000
SUBCONSULTANT		SHEET TITLE
DATE 12/17/2008	DRAWN BY: GS/KG/KB	GATE.12
These drawings are meant for DESIGN INTENT ONLY and are not for construction. Contractor shall verify and be responsible for all dimensions and conditions of the job. Contractor shall be familiar with the site and conditions it presents. This office must be noti-	REVISIONS	Downtown ID
fied of any variations from the dimensions and condi- tions shown on this drawing. Shop drawings and		SHEET NO.
details must be submitted to this office for approval prior to proceeding with fabrication. All copy shall be proofread by client and legal requirements checked		D.7

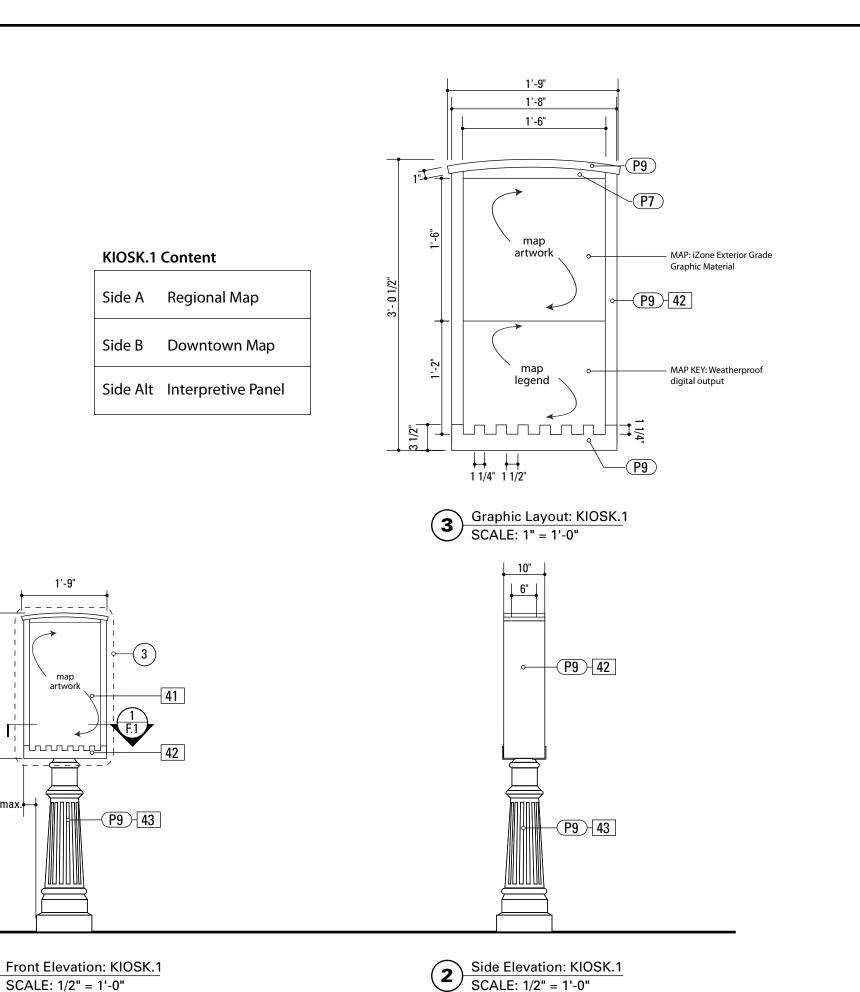

3'-0"

4"max.

SPECIFICATIONS SIGN TYPE: KIOSK.1 FUNCTION: Pedestrian Kiosk

41. SIGN PANEL (TOP) SECTION

PRODUCT NAME: IZONE, 2526 Charter Oak Drive, Suite 100, Temple, Texas 76502-4844

(888) 464-9663 toll free http:/www.izoneimaging.com

email: info@izoneimaging.com

PRODUCT: DIGITAL HIGH PRESSURE PHENOLIC LAMINATE

GRADE:EXTERIOR GRAPHIC APPROVAL SAMPLES: Submit 9 in x 15 in pheno-

lic sample of section of typical project panel for approval of

image quality and color fidelity. WARRANTY PERIOD: Ten years from product ship date.

THICKNESS:1/8 inch

FINISH:UV inhibiting top layer and compatible spray coating. MOUNTING: Mechanical Mounting to display fixture by oth-

SIGN PANEL (BOTTOM) SECTION

PRODUCT NAME: 3M Controltac Scotchprint

PRODUCT: DIGITAL FILM

GRADE:EXTERIOR

GRAPHIC APPROVAL SAMPLES: Submit 9 in x 15 section of typical project panel for approval of image quality and color fidelity.

WARRANTY PERIOD: 3 years from product ship date.

FINISH:UV inhibiting top layer and compatible anti graffiti spray coating.

MOUNTING: Pressure applied to 1/8" aluminum substrate

42. FABRICATED BOX

MATERIAL: 1/8"Thk. Alum. FABRICATION PROCESS: Custom

FASTNER: Mechanically fastened and welded to Post and

Decorative Base

SURFACE PROCESS: Paint all exposed surfaces

EDGES: Routed, finished smooth

COLOR: Custom as noted

43. DECORATIVE CLAMSHELL BASE

PRODUCT: Hapco Homewood Two-Piece Base (HOC), 4" butt diameter, 7 1/2" diameter base EDGES: Smooth COLOR: Custom, as noted

SURFACE PROCESS: Paint all exposed surfaces

FASTENER: Mechanically fastened around 4" pole and Sign

- 1. Fabricator to verify the mounting conditions and provide a detail drawing for each mounting situation, prior to fabrication. Fabricator must obtain approval from the Designer or Client for placement prior to fabrication.
- 2. Welds: All welds shall be ground smooth, paint all seams
- 3. Hardware: All exposed hardware shall be tamper proof fasteners.
- 4. All exposed edges painted to match adjacent face.


details must be submitted to this office for approval


prior to proceeding with fabrication. All copy shall be proofread by client and legal requirements checked

by legal department.

ENVIRONMENTS &	EXPERIENCES	CLIENT / PROJECT
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	www.merjedesign.com	PROJECT NO. Y41.07961.000
UBCONSULTANT		SHEET TITLE
12/17/2008	DRAWN BY: GS/KG/KB	KIOSK.1
hese drawings are meant for DESIGN INTENT ONLY are not for construction. Contractor shall verify	REVISIONS	Pedestrian Kiosk
nd be responsible for all dimensions and conditions f the job. Contractor shall be familiar with the site nd conditions it presents. This office must be noti-		
ed of any variations from the dimensions and condi-		SHEET NO.

D.8

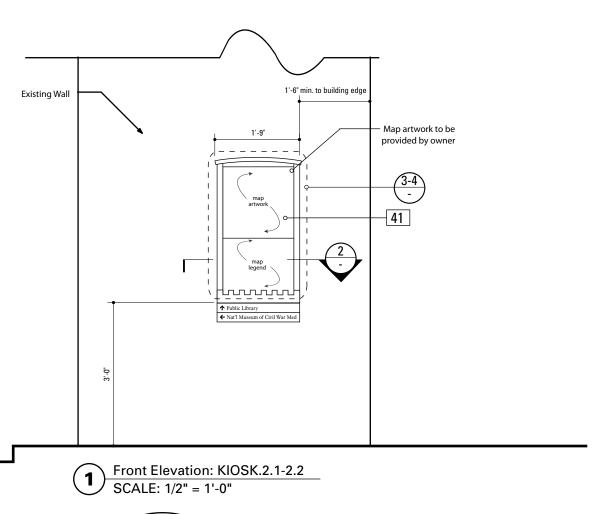

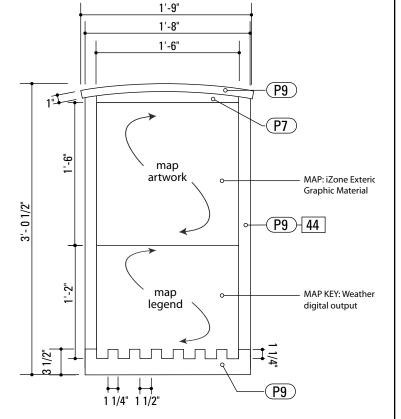


Existing Wall-44 41 Existing Wall-

Section: KIOSK.2

SCALE: 1" = 1'-0"

41

Graphic Layout: KIOSK.2.1 SCALE: 1" = 1'-0"

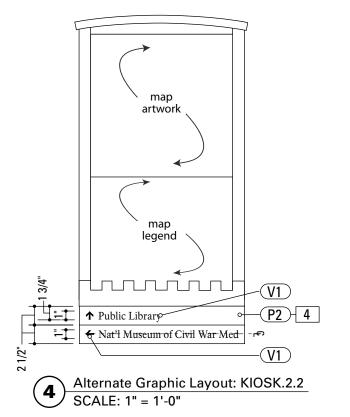

SPECIFICATIONS SIGN TYPE: KIOSK.2 FUNCTION: Pedestrian Kiosk

4. SIGN PANEL

MATERIAL: 1/4" thk Aluminum FABRICATION PROCESS: Contour Cut EDGES: Smooth COLOR: custom, as noted SURFACE PROCESS: Paint all exposed surfaces FASTENER: Continuous weld to sleeve

Vinyl Graphics applied to front face of Sign Panel. See Color Page for Specifications

41. SIGN PANEL (TOP) SECTION

PRODUCT NAME: IZONE, 2526 Charter Oak Drive, Suite 100, Temple, Texas 76502-4844 (888) 464-9663 toll free http://www.izoneimaging.com

email: info@izoneimaging.com

PRODUCT: DIGITAL HIGH PRESSURE PHENOLIC LAMINATE GRADE:EXTERIOR

GRAPHIC APPROVAL SAMPLES: Submit 9 in x 15 in pheno-

lic sample of section of typical project panel for approval of image quality and color fidelity.

WARRANTY PERIOD: Ten years from product ship date.

THICKNESS:1/8 inch

FINISH:UV inhibiting top layer and compatible spray coating. MOUNTING: Mechanical Mounting to display fixture by oth-

SIGN PANEL (BOTTOM) SECTION

PRODUCT NAME: 3M Controltac Scotchprint PRODUCT: DIGITAL FILM

GRADE:EXTERIOR

GRAPHIC APPROVAL SAMPLES: Submit 9 in x 15 section of typical project panel for approval of image quality and color

WARRANTY PERIOD: 3 years from product ship date.

FINISH:UV inhibiting top layer and compatible anti graffiti spray coating.

MOUNTING: Pressure applied to 1/8" aluminum substrate

44. FABRICATED SIGN BACKER

MATERIAL: 1/4"Thk. Alum.

FABRICATION PROCESS: Custom-Router to accept Sign

FASTNER: Mechanically fastened/Silicone to Wall Surface

SURFACE PROCESS: Paint all exposed surfaces

EDGES: Routed, finished smooth

COLOR: Custom as noted

- 1. Fabricator to verify the mounting conditions and provide a detail drawing for each mounting situation, prior to fabrication. Fabricator must obtain approval from the Designer or Client for placement prior to fabrication.
- 2. Welds: All welds shall be ground smooth, paint all seams.
- 3. Hardware: All exposed hardware shall be tamper proof fasteners.
- 4. All exposed edges painted to match adjacent face.

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SUBCONSULTANT		SHEET TITLE
DATE 12/17/2008	DRAWN BY: GS/KG/KB	KIOSK.2
hese drawings are meant for DESIGN INTENT ONLY and are not for construction. Contractor shall verify and be responsible for all dimensions and conditions if the job. Contractor shall be familiar with the site and conditions it presents. This office must be noti-	REVISIONS	Pedestrian Kiosk
independent of the dimensions and condi- ions shown on this drawing. Shop drawings and letails must be submitted to this office for approval rior to proceeding with fabrication. All copy shall be proofread by client and legal requirements checked by legal department.		SHEET NO. D.9


KIOSK.3 Content

Side A Regional Map


Side B Downtown Map

Side C Interpretive Panel


Side Alt Bulletin Board

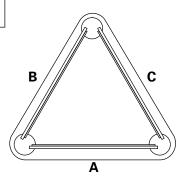


Top View: KIOSK.3 3 SCALE: 1/2" = 1'-0"

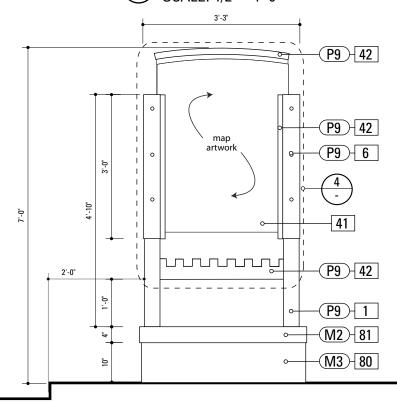

Front Elevation: KIOSK.3 SCALE: 1/2" = 1'-0"

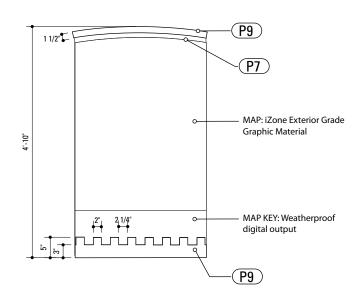

Graphic Layout: KIOSK.3 SCALE: 1/2" = 1'-0"

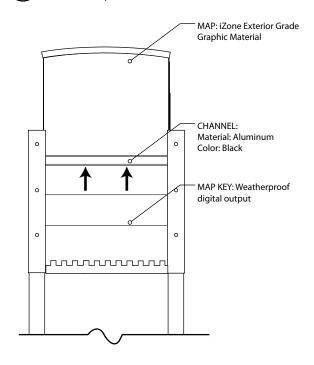

Alternate: KIOSK.3 SCALE: 1/2" = 1'-0"

SPECIFICATIONS

SIGN TYPE: KIOSK.3 FUNCTION: Pedestrian Kiosk

1. 4" ROUND POLE

MATERIAL: 4" dia, 1/4" thick Aluminum round tube FABRICATION PROCESS: Extruded / cut EDGES: Smooth COLOR: Custom, as noted SURFACE PROCESS: Paint all exposed surfaces

SIGN PANEL

MATERIAL: 1/4" thk Aluminum FABRICATION PROCESS: Contour Cut EDGES: Smooth COLOR: custom as noted SURFACE PROCESS: Paint all exposed surfaces FASTENER: Continuous weld to sleeve

Vinyl Graphics applied to front face of Sign Panel. See Color Page for Specifications

41. SIGN PANEL (TOP) SECTION

PRODUCT NAME: IZONE, 2526 Charter Oak Drive, Suite 100, Temple, Texas 76502-4844

(888) 464-9663 toll free http://www.izoneimaging.com email: info@izoneimaging.com

PRODUCT: DIGITAL HIGH PRESSURE PHENOLIC LAMINATE GRADE:EXTERIOR

GRAPHIC APPROVAL SAMPLES: Submit 9 in x 15 in phenolic sample of section of typical project panel for approval of image quality and color fidelity.

WARRANTY PERIOD: Ten years from product ship date.

THICKNESS:1/8 inch

FINISH:UV inhibiting top layer and compatible spray coating. MOUNTING: Mechanical Mounting to display fixture by oth-

SIGN PANEL (BOTTOM) SECTION

PRODUCT NAME: 3M Controltac Scotchprint PRODUCT: DIGITAL FILM

GRADE:EXTERIOR

GRAPHIC APPROVAL SAMPLES: Submit 9 in x 15 section of typical project panel for approval of image quality and color

WARRANTY PERIOD: 3 years from product ship date. FINISH:UV inhibiting top layer and compatible anti graffiti spray coating.

MOUNTING: Pressure applied to 1/8" aluminum substrate

MATERIAL · 1/8"Thk Alum FABRICATION PROCESS: Custom

Decorative Base

SURFACE PROCESS: Paint all exposed surfaces

EDGES: Routed, finished smooth COLOR: Custom as noted

80. BRICK BASE

MATERIAL: Cinderblock base and brick to match streetscape Standard plan or approved equal FABRICATION PROCESS: Cinderblock base, cladded in brick EDGES: Square CORNERS: Square COLOR: Brick FOOTER: Direct Burial/J-Bolt

81. STONE ACCENT HEADER MATERIAL: Stone to match streetscape Standard plan or

approved equal FABRICATION PROCESS: Cinderblock base, cladded in brick FDGFS: Square CORNERS: Square COLOR: Stone

FASTENER: Fabricator Recommended to brick base

42. FABRICATED BOX

FASTNER: Mechanically fastened and welded to Post and

NOTES

- 1. Fabricator to verify the mounting conditions and provide a detail drawing for each mounting situation, prior to fabrication. Fabricator must obtain approval from the Designer or Client for placement prior to fabrication.
- 2. Welds: All welds shall be ground smooth, paint all seams
- 3. Hardware: All exposed hardware shall be tamper proof fasteners.
- 4. All exposed edges painted to match adjacent face.


CLIENT / PROJECT ENVIRONMENTS & EXPERIENCES City of Frederick, MD The Widener Building, Suite 1500 Wayfinding & Signage One South Penn Square Philadelphia, PA 19107 Program T 215.599.4407 F 215.636.9989 www.merjedesign.com PROJECT NO. Y41.07961.000 SUBCONSULTANT SHEET TITLE DRAWN BY: 12/17/2008 GS/KG/KB KIOSK.3 These drawings are meant for DESIGN INTENT ONLY REVISIONS **Pedestrian Kiosk** and are not for construction. Contractor shall verify and be responsible for all dimensions and conditio of the job. Contractor shall be familiar with the site and conditions it presents. This office must be noti-SHEET NO. fied of any variations from the dimensions and cond tions shown on this drawing. Shop drawings and


prior to proceeding with fabrication, All copy shall be proofread by client and legal requirements checked


by legal department.

details must be submitted to this office for approval

D.10

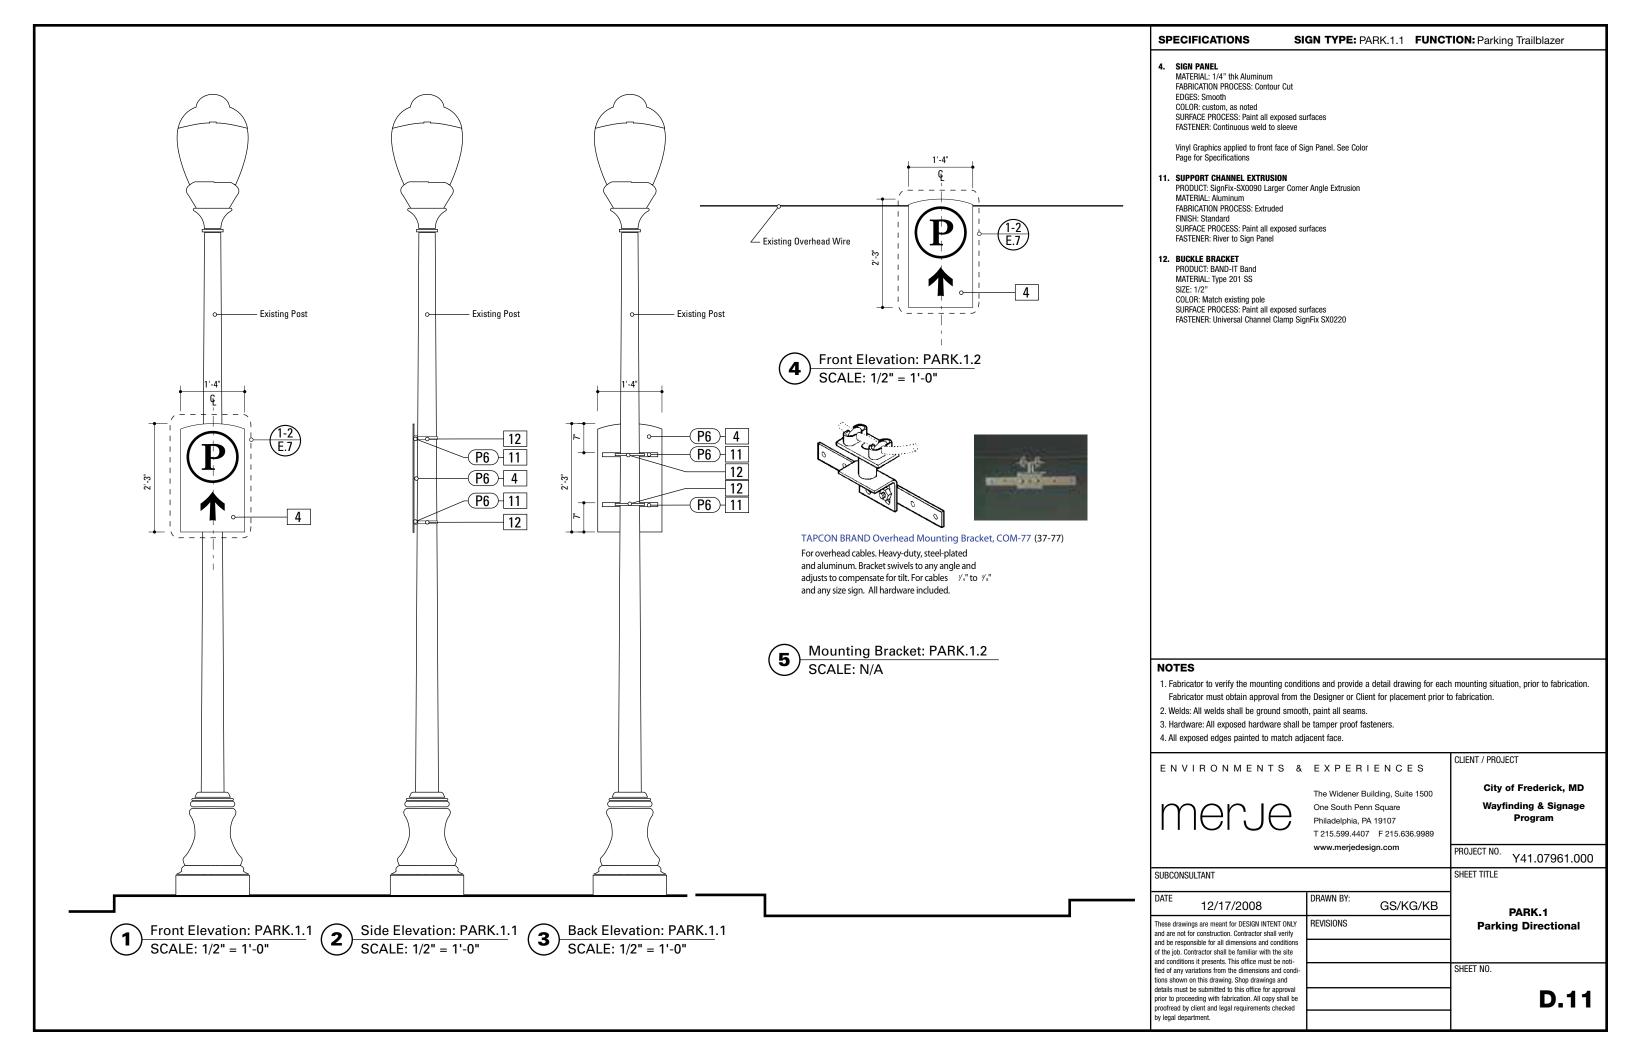

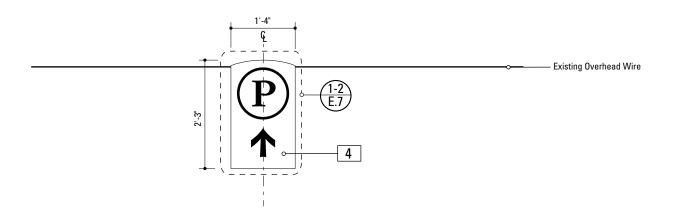

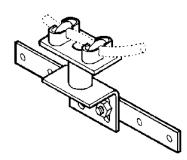



Overhead Mounting Bracket, COM-77 (37-77)

For overhead cables. Heavy-duty, steel-plated and aluminum. Bracket swivels to any angle and adjusts to compensate for tilt. For cables % " to % " and any size sign. All hardware included.

Front Elevation: PARK.1.2 SCALE: 1/2" = 1'-0" Mounting Bracket: PARK.1.2

SCALE: N/A

SPECIFICATIONS

SIGN TYPE: PARK.1.2 **FUNCTION:** Parking Trailblazer

1. 4" ROUND POLE

MATERIAL: 4" dia, 1/4" thick Aluminum round tube FABRICATION PROCESS: Extruded / cut EDGES: Smooth COLOR: Custom, as noted SURFACE PROCESS: Paint all exposed surfaces FOOTER: TRANSPO Break-safe or MDOT approved equal. REFER TO SECTION G FOR FOOTERS

2. DECORATIVE CLAMSHELL BASE

PRODUCT: Hapco Homewood Two-Piece Base (HOC), 4" butt diameter, 7 1/2" diameter base EDGES: Smooth COLOR: Custom, as noted SURFACE PROCESS: Paint all exposed surfaces FASTENER: Mechanically fastened around 4" pole

3. SLEEVE

MATERIAL: 1/4" thk Aluminum square tube
FABRICATION PROCESS: Extruded / cut
EDGES: Smooth
COLOR: custom, as noted
SURFACE PROCESS: Paint all exposed surfaces
FASTENER: Mechanically fastened to pole

4. SIGN PANEL

MATERIAL: 1/4" thk Aluminum
FABRICATION PROCESS: Contour Cut
EDGES: Smooth
COLOR: custom, as noted
SURFACE PROCESS: Paint all exposed surfaces
FASTENER: Continuous weld to sleeve

Vinyl Graphics applied to front face of Sign Panel. See Color Page for Specifications

6. EXPOSED FASTENER


PRODUCT: Heavy Hex Head Bolt SIZE: As required MATERIAL: Stainless Steel FINISH: Painted COLOR: custom, as noted SURFACE PROCESS: Paint all exposed surfaces

NOTES

by legal department.

- 1. Fabricator to verify the mounting conditions and provide a detail drawing for each mounting situation, prior to fabrication. Fabricator must obtain approval from the Designer or Client for placement prior to fabrication.
- 2. Welds: All welds shall be ground smooth, paint all seams.
- 3. Hardware: All exposed hardware shall be tamper proof fasteners.
- 4. All exposed edges painted to match adjacent face.

ENVIRONMENTS &	EXPERIENCES	CLIENT / PROJECT
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DATE 12/17/2008	DRAWN BY: GS/KG/KB	PARK.1.2
These drawings are meant for DESIGN INTENT ONLY and are not for construction. Contractor shall verify and be responsible for all dimensions and conditions of the job. Contractor shall be familiar with the site	REVISIONS	Parking Directional
and conditions it presents. This office must be noti- fied of any variations from the dimensions and condi-		SHEET NO.
tions shown on this drawing. Shop drawings and details must be submitted to this office for approval prior to proceeding with fabrication. All copy shall be proofread by client and legal requirements checked		D.12

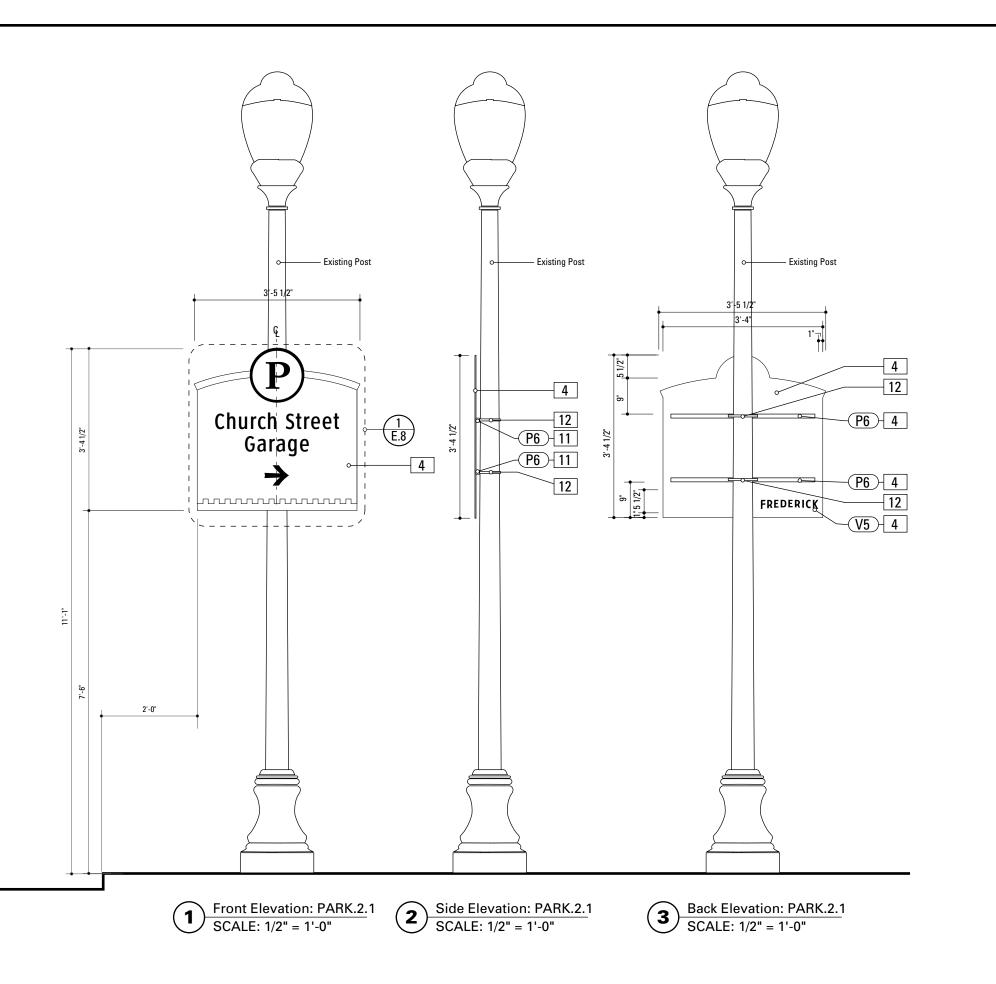

SIGN TYPE: PARK.2.1 **FUNCTION:** Parking Directional

4. SIGN PANEL

MATERIAL: 1/4" thk Aluminum FABRICATION PROCESS: Contour Cut EDGES: Smooth COLOR: custom, as noted

SURFACE PROCESS: Paint all exposed surfaces FASTENER: Continuous weld to sleeve

Vinyl Graphics applied to front face of Sign Panel. See Color Page for Specifications

11. SUPPORT CHANNEL EXTRUSION

PRODUCT: SignFix-SX0090 Larger Corner Angle Extrusion MATERIAL: Aluminum FABRICATION PROCESS: Extruded FINISH: Standard SURFACE PROCESS: Paint all exposed surfaces FASTENER: River to Sign Panel

12. BUCKLE BRACKET PRODUCT: BAND-IT Band

MATERIAL: Type 201 SS SIZE: 1/2" COLOR: Match existing pole SURFACE PROCESS: Paint all exposed surfaces FASTENER: Universal Channel Clamp SignFix SX0220


NOTES

- 1. Fabricator to verify the mounting conditions and provide a detail drawing for each mounting situation, prior to fabrication. Fabricator must obtain approval from the Designer or Client for placement prior to fabrication.
- $2.\,Welds: All\,\,welds\,\,shall\,\,be\,\,ground\,\,smooth,\,paint\,\,all\,\,seams.$
- 3. Hardware: All exposed hardware shall be tamper proof fasteners.
- 4. All exposed edges painted to match adjacent face.

prior to proceeding with fabrication. All copy shall be proofread by client and legal requirements checked

by legal department.

CLIENT / PROJECT ENVIRONMENTS & EXPERIENCES City of Frederick, MD The Widener Building, Suite 1500 Wayfinding & Signage One South Penn Square Philadelphia, PA 19107 Program T 215.599.4407 F 215.636.9989 www.merjedesign.com PROJECT NO. Y41.07961.000 SHEET TITLE SUBCONSULTANT DRAWN BY: 12/17/2008 GS/KG/KB PARK.2 REVISIONS These drawings are meant for DESIGN INTENT ONLY **Parking Directional** and are not for construction. Contractor shall verify and be responsible for all dimensions and condition of the job. Contractor shall be familiar with the site and conditions it presents. This office must be noti-SHEET NO. fied of any variations from the dimensions and condi tions shown on this drawing. Shop drawings and details must be submitted to this office for approval

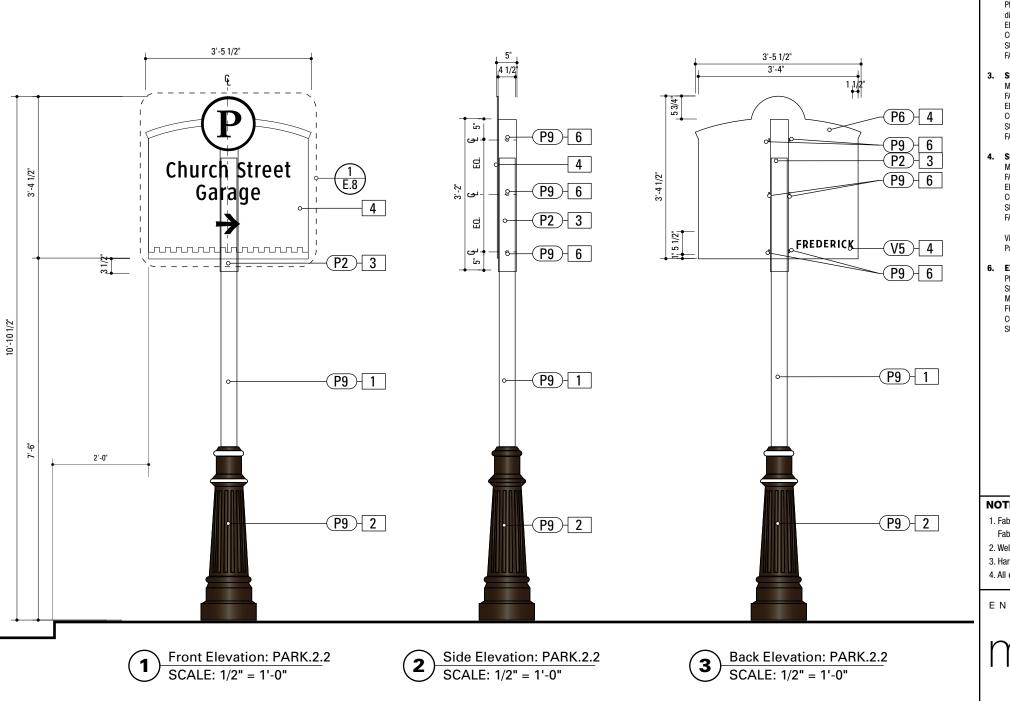

SPECIFICATIONS SIGN TYPE: PARK.2.2 **FUNCTION:** Parking Directional

1. 4" ROUND POLE

MATERIAL: 4" dia, 1/4" thick Aluminum round tube FABRICATION PROCESS: Extruded / cut EDGES: Smooth COLOR: Custom, as noted SURFACE PROCESS: Paint all exposed surfaces FOOTER: TRANSPO Break-safe or MDOT approved equal. REFER TO SECTION G FOR FOOTERS

2. DECORATIVE CLAMSHELL BASE

PRODUCT: Hapco Homewood Two-Piece Base (HOC), 4" butt diameter, 7 1/2" diameter base FDGFS: Smooth COLOR: Custom, as noted SURFACE PROCESS: Paint all exposed surfaces FASTENER: Mechanically fastened around 4" pole

3. SLEEVE

MATERIAL: 1/4" thk Aluminum square tube FABRICATION PROCESS: Extruded / cut EDGES: Smooth COLOR: custom, as noted SURFACE PROCESS: Paint all exposed surfaces FASTENER: Mechanically fastened to pole

SIGN PANEL

MATERIAL: 1/4" thk Aluminum FABRICATION PROCESS: Contour Cut EDGES: Smooth COLOR: custom, as noted SURFACE PROCESS: Paint all exposed surfaces FASTENER: Continuous weld to sleeve

Vinyl Graphics applied to front face of Sign Panel. See Color Page for Specifications

EXPOSED FASTENER

PRODUCT: Heavy Hex Head Bolt SIZE: As required MATERIAL: Stainless Steel FINISH: Painted COLOR: custom, as noted SURFACE PROCESS: Paint all exposed surfaces

NOTES

by legal department.

- 1. Fabricator to verify the mounting conditions and provide a detail drawing for each mounting situation, prior to fabrication. Fabricator must obtain approval from the Designer or Client for placement prior to fabrication.
- 2. Welds: All welds shall be ground smooth, paint all seams
- 3. Hardware: All exposed hardware shall be tamper proof fasteners.
- 4. All exposed edges painted to match adjacent face.

and are not for construction. Contractor shall verify and be responsible for all dimensions and condition of the job. Contractor shall be familiar with the site and conditions it presents. This office must be noti-


fied of any variations from the dimensions and condi tions shown on this drawing. Shop drawings and details must be submitted to this office for approval

prior to proceeding with fabrication. All copy shall be proofread by client and legal requirements checked

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	www.merjedesign.com	PROJECT NO. Y41.07961.00
SUBCONSULTANT		SHEET TITLE
DATE 12/17/2008	DRAWN BY: GS/KG/KB	PARK.2.2
These drawings are meant for DESIGN INTENT ONLY	REVISIONS	Parking Directional

> PARK.2.2 **Parking Directional**

SHEET NO.

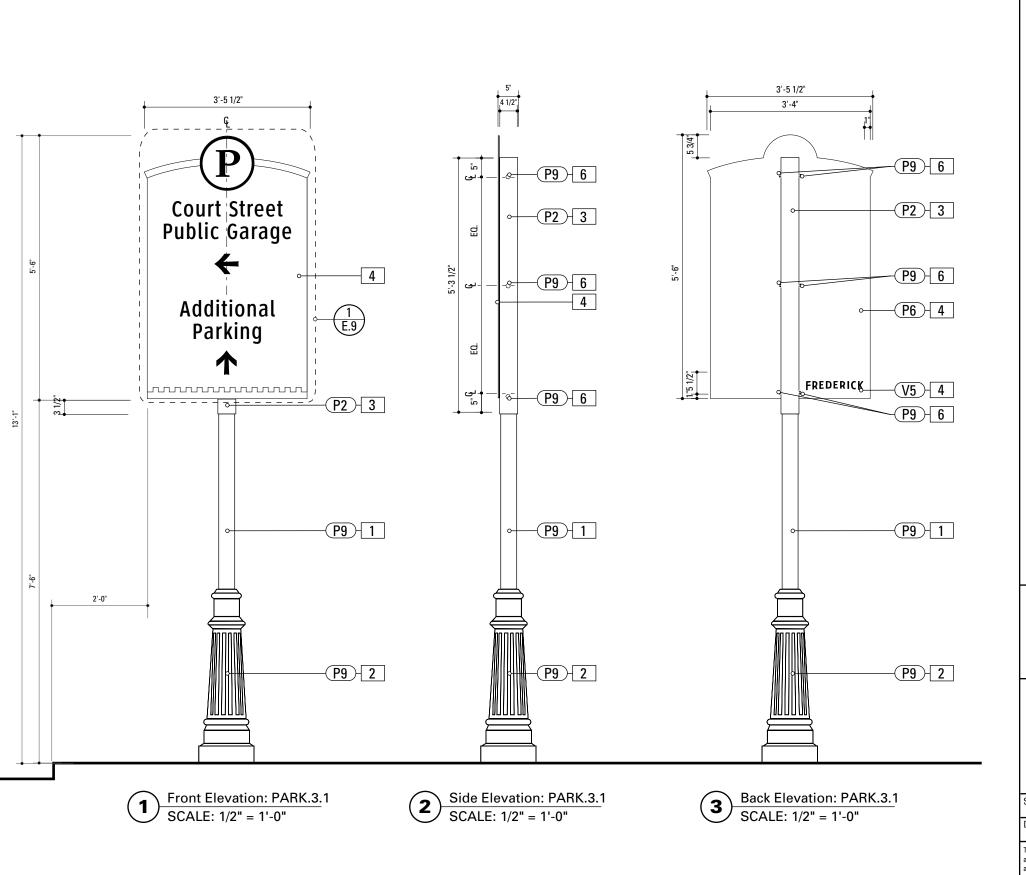

SPECIFICATIONS SIGN TYPE: PARK.3 FUNCTION: Parking Directional

1. 4" ROUND POLE

MATERIAL: 4" dia, 1/4" thick Aluminum round tube FABRICATION PROCESS: Extruded / cut EDGES: Smooth COLOR: Custom, as noted SURFACE PROCESS: Paint all exposed surfaces FOOTER: TRANSPO Break-safe or MDOT approved equal. REFER TO SECTION G FOR FOOTERS

2. DECORATIVE CLAMSHELL BASE

PRODUCT: Hapco Homewood Two-Piece Base (HOC), 4" butt diameter, 7 1/2" diameter base FDGFS: Smooth COLOR: Custom, as noted SURFACE PROCESS: Paint all exposed surfaces FASTENER: Mechanically fastened around 4" pole

3. SLEEVE

MATERIAL: 1/4" thk Aluminum square tube FABRICATION PROCESS: Extruded / cut EDGES: Smooth COLOR: custom, as noted SURFACE PROCESS: Paint all exposed surfaces FASTENER: Mechanically fastened to pole

SIGN PANEL

MATERIAL: 1/4" thk Aluminum FABRICATION PROCESS: Contour Cut EDGES: Smooth COLOR: custom, as noted SURFACE PROCESS: Paint all exposed surfaces FASTENER: Continuous weld to sleeve

Vinyl Graphics applied to front face of Sign Panel. See Color Page for Specifications

EXPOSED FASTENER

PRODUCT: Heavy Hex Head Bolt SIZE: As required MATERIAL: Stainless Steel FINISH: Painted COLOR: custom, as noted SURFACE PROCESS: Paint all exposed surfaces

- 1. Fabricator to verify the mounting conditions and provide a detail drawing for each mounting situation, prior to fabrication. Fabricator must obtain approval from the Designer or Client for placement prior to fabrication.
- 2. Welds: All welds shall be ground smooth, paint all seams
- 3. Hardware: All exposed hardware shall be tamper proof fasteners.
- 4. All exposed edges painted to match adjacent face.

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ATE 12/17/2008	DRAWN BY: GS/KG/KB
nese drawings are meant for DESIGN INTENT ONLY nd are not for construction. Contractor shall verify nd be responsible for all dimensions and conditions	REVISIONS
f the job. Contractor shall be familiar with the site	

and conditions it presents. This office must be notified of any variations from the dimensions and condi tions shown on this drawing. Shop drawings and details must be submitted to this office for approval

prior to proceeding with fabrication. All copy shall be proofread by client and legal requirements checked

by legal department.


CLIENT / PROJECT

SHEET TITLE

City of Frederick, MD Wayfinding & Signage Program

PROJECT NO. Y41.07961.000

GS/KG/KB PARK.3.1 **Parking Directional**

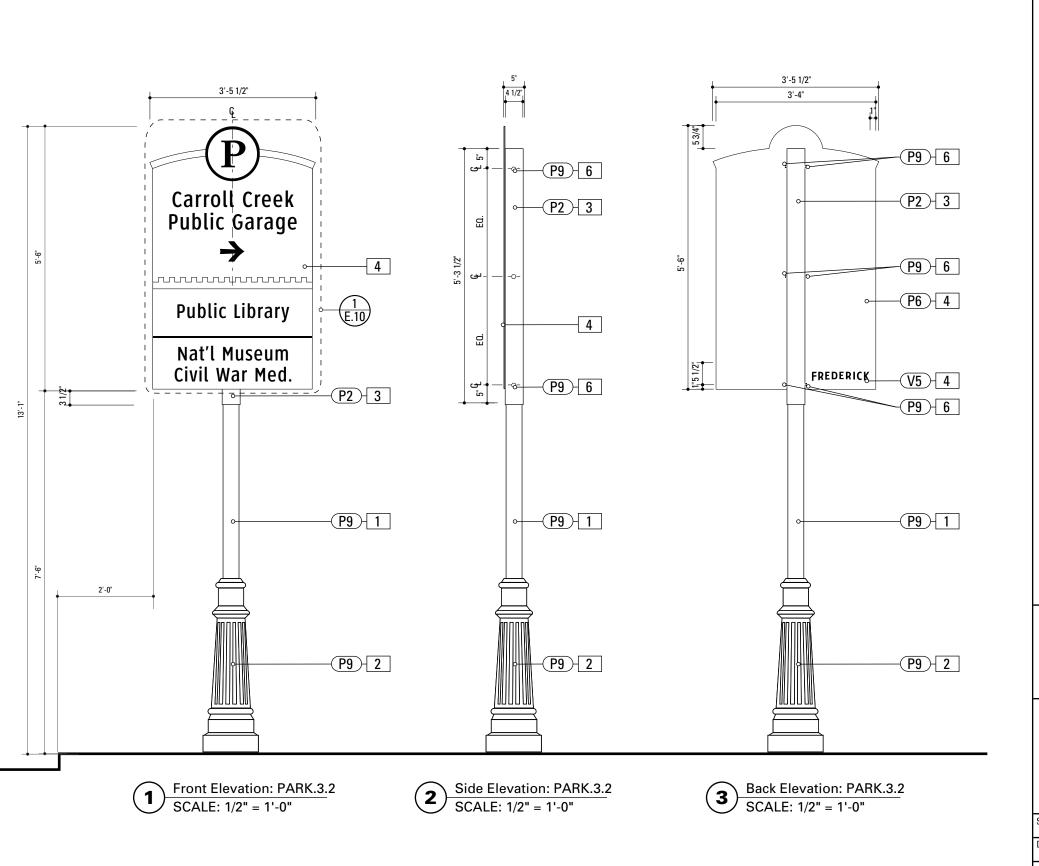

SPECIFICATIONS SIGN TYPE: PARK.4 FUNCTION: Parking Directional

1. 4" ROUND POLE

MATERIAL: 4" dia, 1/4" thick Aluminum round tube FABRICATION PROCESS: Extruded / cut EDGES: Smooth COLOR: Custom, as noted SURFACE PROCESS: Paint all exposed surfaces FOOTER: TRANSPO Break-safe or MDOT approved equal. REFER TO SECTION G FOR FOOTERS

2. DECORATIVE CLAMSHELL BASE

PRODUCT: Hapco Homewood Two-Piece Base (HOC), 4" butt diameter, 7 1/2" diameter base FDGFS: Smooth COLOR: Custom, as noted SURFACE PROCESS: Paint all exposed surfaces FASTENER: Mechanically fastened around 4" pole

3. SLEEVE

MATERIAL: 1/4" thk Aluminum square tube FABRICATION PROCESS: Extruded / cut EDGES: Smooth COLOR: custom, as noted SURFACE PROCESS: Paint all exposed surfaces FASTENER: Mechanically fastened to pole

SIGN PANEL

MATERIAL: 1/4" thk Aluminum FABRICATION PROCESS: Contour Cut EDGES: Smooth COLOR: custom, as noted SURFACE PROCESS: Paint all exposed surfaces FASTENER: Continuous weld to sleeve

Vinyl Graphics applied to front face of Sign Panel. See Color Page for Specifications

EXPOSED FASTENER

PRODUCT: Heavy Hex Head Bolt SIZE: As required MATERIAL: Stainless Steel FINISH: Painted COLOR: custom, as noted SURFACE PROCESS: Paint all exposed surfaces

- 1. Fabricator to verify the mounting conditions and provide a detail drawing for each mounting situation, prior to fabrication. Fabricator must obtain approval from the Designer or Client for placement prior to fabrication.
- 2. Welds: All welds shall be ground smooth, paint all seams
- 3. Hardware: All exposed hardware shall be tamper proof fasteners.
- 4. All exposed edges painted to match adjacent face.

of the job. Contractor shall be familiar with the site and conditions it presents. This office must be notified of any variations from the dimensions and condi tions shown on this drawing. Shop drawings and details must be submitted to this office for approval

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by legal department.

CLIENT / PROJECT ENVIRONMENTS & EXPERIENCES The Widener Building, Suite 1500 One South Penn Square Philadelphia, PA 19107 T 215.599.4407 F 215.636.9989 www.merjedesign.com SUBCONSULTANT SHEET TITLE DRAWN BY: 12/17/2008 GS/KG/KB REVISIONS These drawings are meant for DESIGN INTENT ONLY and are not for construction. Contractor shall verify and be responsible for all dimensions and condition


PROJECT NO. Y41.07961.000

City of Frederick, MD

Wayfinding & Signage

Program

PARK.3.2 Parking Directional

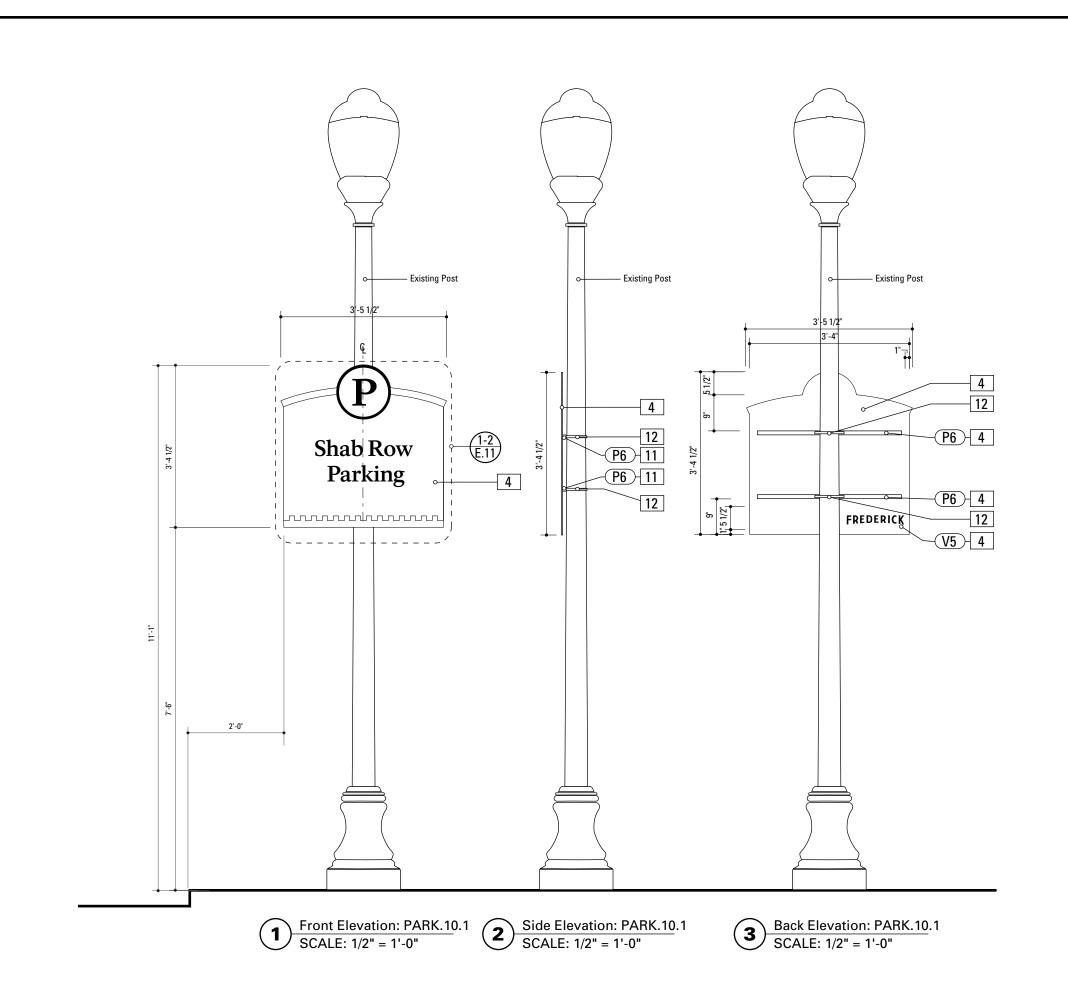

SIGN TYPE: PARK.10.1 **FUNCTION:** Parking Identification

4. SIGN PANEL

MATERIAL: 1/4" thk Aluminum FABRICATION PROCESS: Contour Cut EDGES: Smooth COLOR: custom, as noted SURFACE PROCESS: Paint all exposed surfaces

FASTENER: Continuous weld to sleeve

Vinyl Graphics applied to front face of Sign Panel. See Color Page for Specifications

. ..g. ... -p.....

11. SUPPORT CHANNEL EXTRUSION

PRODUCT: SignFix-SX0090 Larger Corner Angle Extrusion MATERIAL: Aluminum FABRICATION PROCESS: Extruded FINISH: Standard SURFACE PROCESS: Paint all exposed surfaces FASTENER: River to Sign Panel

12. BUCKLE BRACKET PRODUCT: BAND-IT Band

MATERIAL: Type 201 SS SIZE: 1/2" COLOR: Match existing pole SURFACE PROCESS: Paint all exposed surfaces FASTENER: Universal Channel Clamp SignFix SX0220


NOTES

1. Fabricator to verify the mounting conditions and provide a detail drawing for each mounting situation, prior to fabrication. Fabricator must obtain approval from the Designer or Client for placement prior to fabrication.

CLIENT / PROJECT

- 2. Welds: All welds shall be ground smooth, paint all seams.
- 3. Hardware: All exposed hardware shall be tamper proof fasteners.
- 4. All exposed edges painted to match adjacent face.

ENVIRONMENTS & EXPERIENCES City of Frederick, MD The Widener Building, Suite 1500 Wayfinding & Signage One South Penn Square Program Philadelphia, PA 19107 T 215.599.4407 F 215.636.9989 www.merjedesign.com PROJECT NO. Y41.07961.000 SHEET TITLE SUBCONSULTANT DRAWN BY: 12/17/2008 GS/KG/KB PARK.10.1 REVISIONS These drawings are meant for DESIGN INTENT ONLY **Parking Directional** and are not for construction. Contractor shall verify and be responsible for all dimensions and condition of the job. Contractor shall be familiar with the site and conditions it presents. This office must be notified of any variations from the dimensions and condi tions shown on this drawing. Shop drawings and details must be submitted to this office for approval **D.17** prior to proceeding with fabrication. All copy shall be proofread by client and legal requirements checked by legal department.

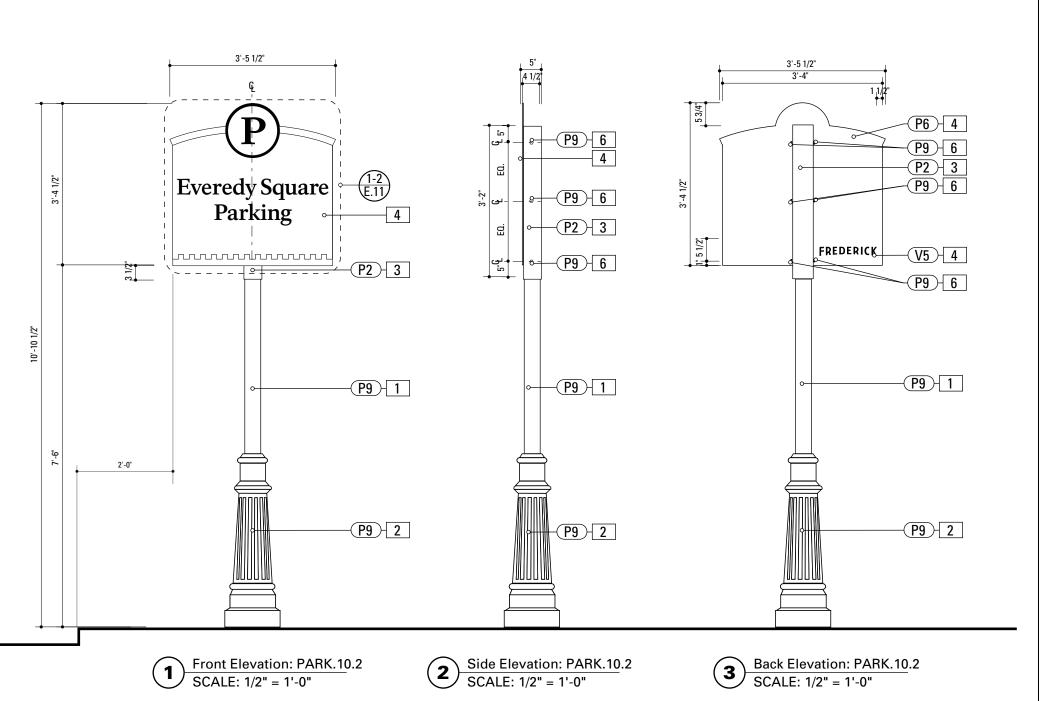

SIGN TYPE: PARK.10.2 **FUNCTION:** Parking Identification

1. 4" ROUND POLE

MATERIAL: 4" dia, 1/4" thick Aluminum round tube FABRICATION PROCESS: Extruded / cut EDGES: Smooth COLOR: Custom, as noted SURFACE PROCESS: Paint all exposed surfaces FOOTER: TRANSPO Break-safe or MDOT approved equal. REFER TO SECTION G FOR FOOTERS

2. DECORATIVE CLAMSHELL BASE

PRODUCT: Hapco Homewood Two-Piece Base (HOC), 4" butt diameter, 7 1/2" diameter base EDGES: Smooth COLOR: Custom, as noted SURFACE PROCESS: Paint all exposed surfaces FASTENER: Mechanically fastened around 4" pole

3. SLEEVE

MATERIAL: 1/4" thk Aluminum square tube FABRICATION PROCESS: Extruded / cut EDGES: Smooth COLOR: custom, as noted SURFACE PROCESS: Paint all exposed surfaces FASTENER: Mechanically fastened to pole

4. SIGN PANEL

MATERIAL: 1/4" thk Aluminum
FABRICATION PROCESS: Contour Cut
EDGES: Smooth
COLOR: custom, as noted
SURFACE PROCESS: Paint all exposed surfaces
FASTENER: Continuous weld to sleeve

Vinyl Graphics applied to front face of Sign Panel. See Color Page for Specifications

6. EXPOSED FASTENER

PRODUCT: Heavy Hex Head Bolt SIZE: As required MATERIAL: Stainless Steel FINISH: Painted COLOR: custom, as noted SURFACE PROCESS: Paint all exposed surfaces

NOTES

Fabricator to verify the mounting conditions and provide a detail drawing for each mounting situation, prior to fabrication.
 Fabricator must obtain approval from the Designer or Client for placement prior to fabrication.

CLIENT / PROJECT

D.18

- 2. Welds: All welds shall be ground smooth, paint all seams.
- 3. Hardware: All exposed hardware shall be tamper proof fasteners.

ENVIRONMENTS & EXPERIENCES


4. All exposed edges painted to match adjacent face.


details must be submitted to this office for approval

prior to proceeding with fabrication. All copy shall be proofread by client and legal requirements checked

by legal department.

The Widener Building, Suite One South Penn Square Philadelphia, PA 19107 T 215.599.4407 F 215.636.		Square 19107 F 215.636.9989	1	of Frederick, MD inding & Signage Program
	www.merjedesi	gn.com	PROJECT NO.	Y41.07961.00
SUBCONSULTANT			SHEET TITLE	
DATE 12/17/2008	DRAWN BY:	GS/KG/KB] ,	PARK.10.2
These drawings are meant for DESIGN INTENT ONLY and are not for construction. Contractor shall verify and be responsible for all dimensions and conditions of the job. Contractor shall be familiar with the site and conditions it presents. This office must be noti-	REVISIONS		Parki	ng Directional
fied of any variations from the dimensions and condi- tions shown on this drawing. Shop drawings and			SHEET NO.	

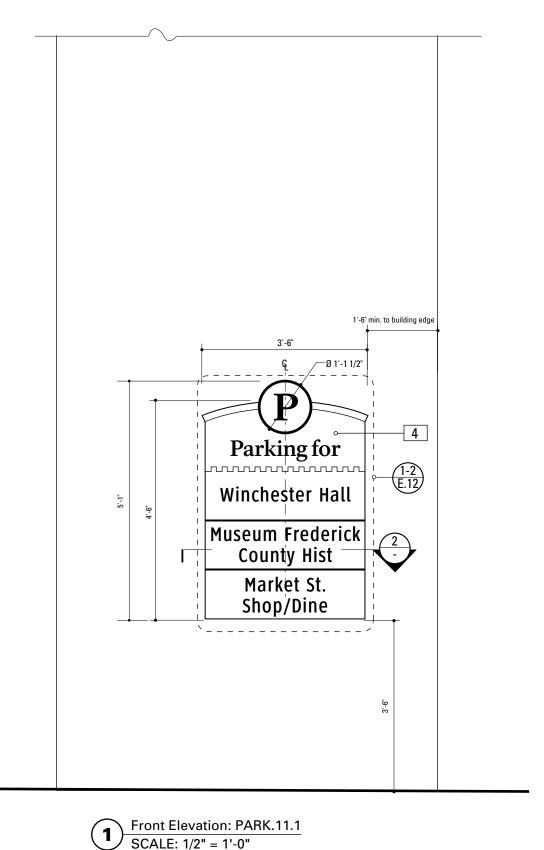

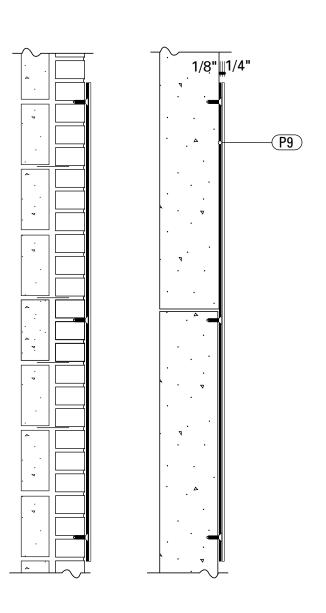

Section: PARK.11.1 SCALE: 1" = 1'-0"

SPECIFICATIONS

SIGN TYPE: PARK.11.1 **FUNCTION:** Parking ID with listing

4. SIGN PANEL

MATERIAL: 1/4" thk Aluminum FABRICATION PROCESS: Square Cut

EDGES: Smooth

SURFACE PROCESS: Paint all exposed surfaces FASTENER: Chemically Welded to Backer Panel

BACKER PANEL

COLOR: custom, as noted

MATERIAL: 1/8" thk Aluminum

FABRICATION PROCESS: Square Cut to match dimensions of

sian panel

EDGES: Smooth COLOR: custom, as noted

SURFACE PROCESS: Paint all exposed surfaces

FASTENER: mechanically fasten to existing wall. Anchor suitable for wall material. Allowable shear capacity of anchor = 50 lbs. (min). 8 Anchors, with 1 anchor placed

at each corner. Stud Mount Welded or countersunk to sign

COPY ARROW RULE BACKGROUND


PRODUCT: 3M Engineer Grade reflective sheeting

MATERIAL: vinyl
FABRICATION PROCESS: Electronically cut / Applied

COLOR: custom, as noted

- 1. Fabricator to verify the mounting conditions and provide a detail drawing for each mounting situation, prior to fabrication. Fabricator must obtain approval from the Designer or Client for placement prior to fabrication.
- 2. Welds: All welds shall be ground smooth, paint all seams
- 3. Hardware: All exposed hardware shall be tamper proof fasteners.
- 4. All exposed edges painted to match adjacent face.

ENVIRONMENTS &	EXPERIENCES	CLIENT / PROJECT
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	www.merjedesign.com	PROJECT NO. Y41.07961.000
SUBCONSULTANT		SHEET TITLE
DATE 12/17/2008	DRAWN BY: GS/KG/KB	PARK.11.1
These drawings are meant for DESIGN INTENT ONLY and are not for construction. Contractor shall verify and be responsible for all dimensions and conditions of the job. Contractor shall be familiar with the site	REVISIONS	Parking Directional
and are not for construction. Contractor shall verify and be responsible for all dimensions and conditions	REVISIONS	Parking Directional SHEET NO.

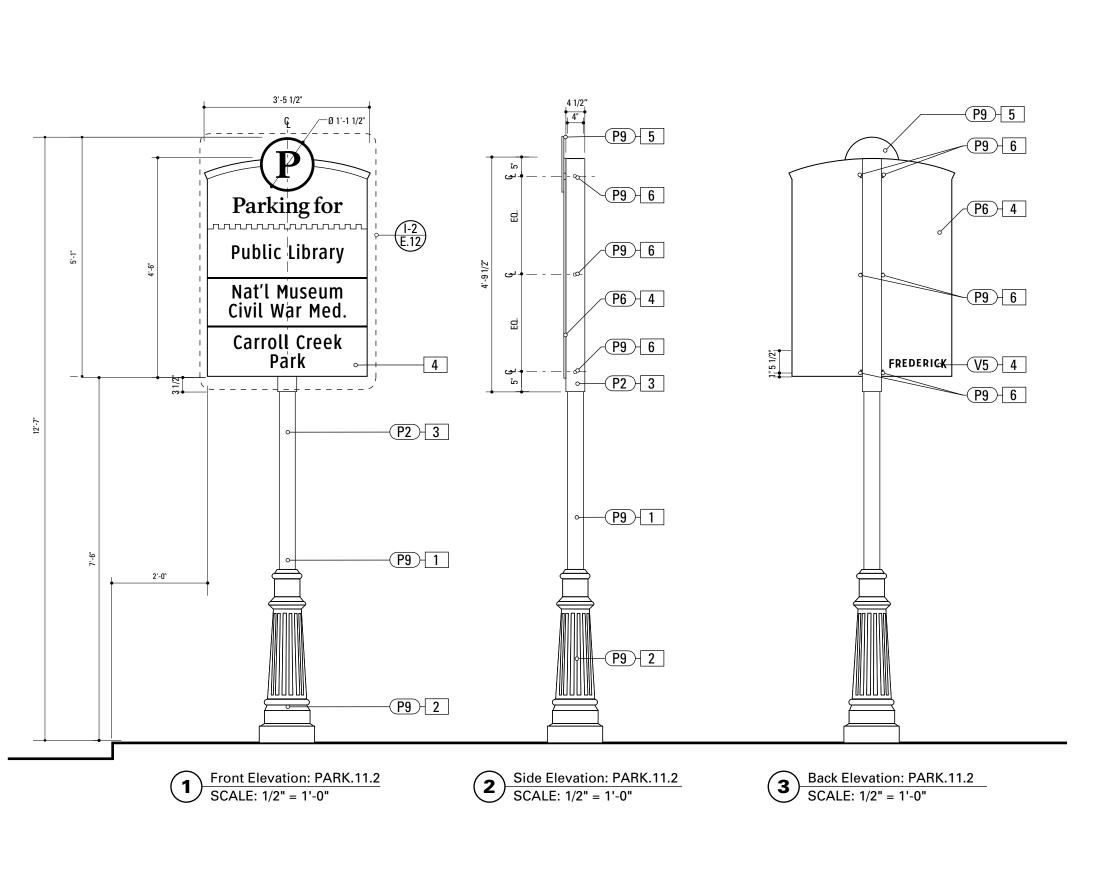

SIGN TYPE: PARK.11.2 **FUNCTION:** Parking ID with listings

1. 4" ROUND POLE

MATERIAL: 4" dia, 1/4" thick Aluminum round tube FABRICATION PROCESS: Extruded / cut EDGES: Smooth COLOR: Custom, as noted SURFACE PROCESS: Paint all exposed surfaces FOOTER: TRANSPO Break-safe or MDOT approved equal. REFER TO SECTION G FOR FOOTERS

2. DECORATIVE CLAMSHELL BASE

PRODUCT: Hapco Homewood Two-Piece Base (HOC), 4" butt diameter, 7 1/2" diameter base FDGFS: Smooth COLOR: Custom, as noted SURFACE PROCESS: Paint all exposed surfaces FASTENER: Mechanically fastened around 4" pole

3. SLEEVE

MATERIAL: 1/4" thk Aluminum square tube FABRICATION PROCESS: Extruded / cut EDGES: Smooth COLOR: custom, as noted SURFACE PROCESS: Paint all exposed surfaces FASTENER: Mechanically fastened to pole

SIGN PANEL

MATERIAL: 1/4" thk Aluminum FABRICATION PROCESS: Contour Cut EDGES: Smooth COLOR: custom, as noted SURFACE PROCESS: Paint all exposed surfaces FASTENER: Continuous weld to sleeve

Vinyl Graphics applied to front face of Sign Panel. See Color Page for Specifications

EXPOSED FASTENER

PRODUCT: Heavy Hex Head Bolt SIZE: As required MATERIAL: Stainless Steel FINISH: Painted COLOR: custom, as noted SURFACE PROCESS: Paint all exposed surfaces

NOTES

- 1. Fabricator to verify the mounting conditions and provide a detail drawing for each mounting situation, prior to fabrication. Fabricator must obtain approval from the Designer or Client for placement prior to fabrication.
- 2. Welds: All welds shall be ground smooth, paint all seams
- 3. Hardware: All exposed hardware shall be tamper proof fasteners.
- 4. All exposed edges painted to match adjacent face.

fied of any variations from the dimensions and conditions shown on this drawing. Shop drawings and details must be submitted to this office for approval

prior to proceeding with fabrication. All copy shall be proofread by client and legal requirements checked

by legal department.

ENVIRONMENTS &	EXPERIENCES	CLIENT / PRO
merje	The Widener Building, Suite 1500 One South Penn Square Philadelphia, PA 19107 T 215.599.4407 F 215.636.9989 www.merjedesign.com	City Way
SUBCONSULTANT		SHEET TITLE
DATE 12/17/2008	DRAWN BY: GS/KG/KB	
These drawings are meant for DESIGN INTENT ONLY and are not for construction. Contractor shall verify	REVISIONS	Park
and be responsible for all dimensions and conditions of the job. Contractor shall be familiar with the site		


CLIENT / PROJECT

of Frederick, MD finding & Signage Program

Y41.07961.000

PARK.11.2 ing Directional

SHEET NO.

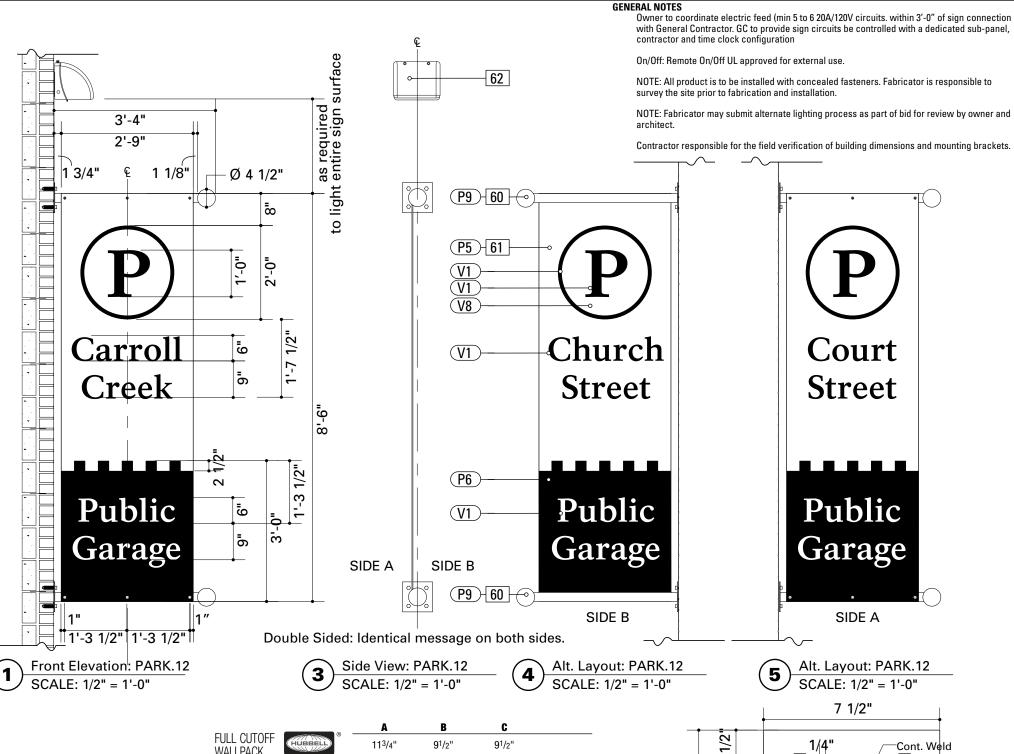

APPLICATIONS

Use for wall perimeter or entry at mounting heights of 8-15 feet.
 The StarView compliant optics allow no up light, saving energy and keeping the neighbors happy!

SPECIFICATIONS


- The decorative styling is also rugged with one piece polycarbonate front, painted bronze or white on the inside, that resists rocks and other small projectiles.
- The die cast housing provides rigid mounting, conduit and photocontrol hubs, easy mount design and heat dissipation.

LISTINGS

CSA certified to UL 1598 for use in wet locations.




Star View. compliant

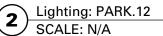

FULL CUTOFF WALLPACK NRG***1100 SERIES Outdoor Lighting 298 mm 241 mm 241 mm

Catalog Number ¹	Wattage/Voltage	Finish	Weight
			lbs. kg
PULSE START METAL HALIDE			
NRG-1111B	100 PS 120, 277, 347	bronze	12 5.4
PBT-1	Photocontrol, button type, 120 volt		

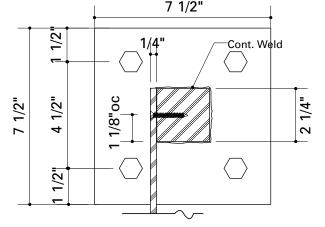

Section: PARK.12

SCALE: 1/8" = 1"

SPECIFICATIONS

SIGN TYPE: PARK.12 FUNCTION: Parking ID Banner

60. MOUNTING POLE

QTY (2) per assembly
MATERIAL: Aluminum
FABRICATION PROCESS: ASSEMBLY/WELDED
EDGES: Smooth
COLOR: custom, as noted
SURFACE PROCESS: Paint all exposed surfaces
FASTENER: mechanically fasten to existing wall. Anch

SURFACE PROCESS: Paint all exposed surfaces FASTENER: mechanically fasten to existing wall. Anchor suitable for wall material. Allowable shear capacity of anchor = 100 lbs. (min). 8 Anchors, with 1 anchor placed at each corner.

COPY ARROW RULE BACKGROUND

PRODUCT: 3M Engineer Grade reflective sheeting MATERIAL: vinyl FABRICATION PROCESS: Electronically cut / Applied COLOR: custom. as noted

61. SIGN PANEL

SIDES: Double

MATERIAL: 1/4" thk Aluminum
FABRICATION PROCESS: Contour Cut
EDGES: Smooth
COLOR: custom, as noted
SURFACE PROCESS: Paint all exposed surfaces
FASTENER: Continuous weld to sleeve

Vinyl Graphics applied to Front and Rear face of Sign Panel. See Color Page for Specifications

62. LIGHT FIXTURE

MANUFACTURER: AS SHOWN or approved equal NOTE: Fabricator is responsible for surveying the locations on site prior to fabrication and installation to ensure proper structural and mounting requirements are met.

Owner and installer to coordinate electric feed within 3'-0" of sign connection prior to installation.

Power supplies should be remotely installed inside of sign, send voltage wiring through fascia.

All product is to installed with concealed fasteners.

- Fabricator to verify the mounting conditions and provide a detail drawing for each mounting situation, prior to fabrication.
 Fabricator must obtain approval from the Designer or Client for placement prior to fabrication.
- 2. Welds: All welds shall be ground smooth, paint all seams.
- 3. Hardware: All exposed hardware shall be tamper proof fasteners.
- 4. All exposed edges painted to match adjacent face.



GENERAL NOTES

Owner to coordinate electric feed (min 5 to 6 20A/120V circuits. within 3'-0" of sign connection with General Contractor. GC to provide sign circuits be controlled with a dedicated sub-panel, contractor and time clock configuration.

Power supplies should be remotely installed inside of sign, send low voltage wiring through fascia.


On/Off: Remote On/Off UL approved for external use.

Quantity: Computer Lumen Analysis to be provided from the manufacturer for minimum specified foot candle or Nit level Fabricator is responsible for the quantity of LEDS required. Provide a 30% inventory of LEDS for future servicing.

NOTE: All product is to be installed with concealed fasteners. Fabricator is responsible to survey the site prior to fabrication and installation.

NOTE: Fabricator may submit alternate lighting process as part of bid for review by owner and architect.

Contractor responsible for the field verification of building dimensions and mounting brackets.

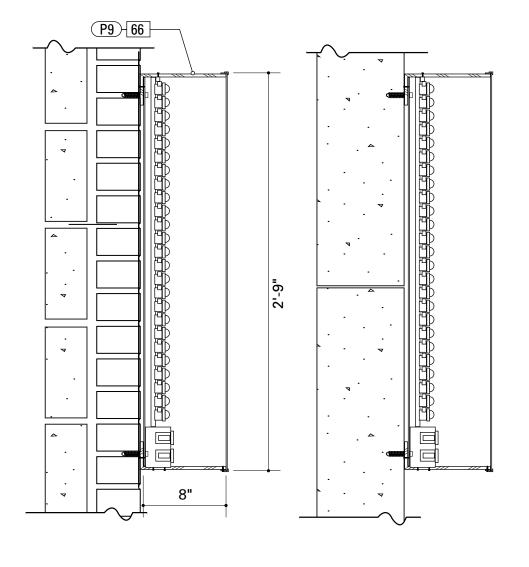


Section Detail: PARK.13
SCALE: 1 1/2" = 1'-0"


SPECIFICATIONS SIGN TYPE: PARK.13 FUNCTION: Parking Identification

66. MONOLITH (Wall Mounted)SIGN FACE LEGULARY LIGHT FIXTURELED HOUSING HARDWARE

- 1. Fabricator to verify the mounting conditions and provide a detail drawing for each mounting situation, prior to fabrication. Fabricator must obtain approval from the Designer or Client for placement prior to fabrication.
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- 3. Hardware: All exposed hardware shall be tamper proof fasteners.
- 4. All exposed edges painted to match adjacent face.

ENVIRONMENTS &	EXPERIENCES	CLIENT / PROJECT
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	www.merjedesign.com	PROJECT NO. Y41.07961.000
SUBCONSULTANT		SHEET TITLE
DATE 12/17/2008	DRAWN BY: GS/KG/KB	PARK.13 Parking ID
hese drawings are meant for DESIGN INTENT ONLY	REVISIONS	raikiliy ib
and are not for construction. Contractor shall verify and be responsible for all dimensions and conditions of the job. Contractor shall be familiar with the site and conditions it presents. This office must be noti-	REVISIONS	

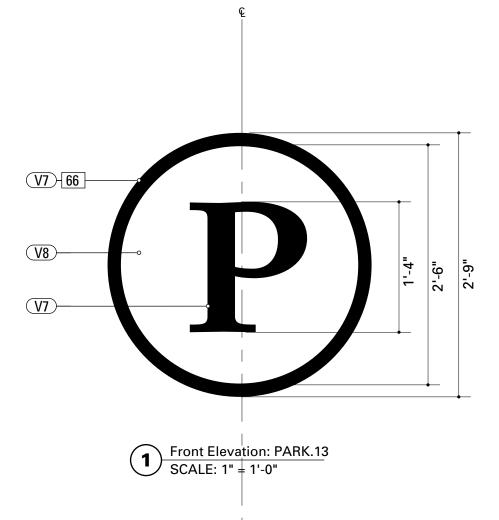

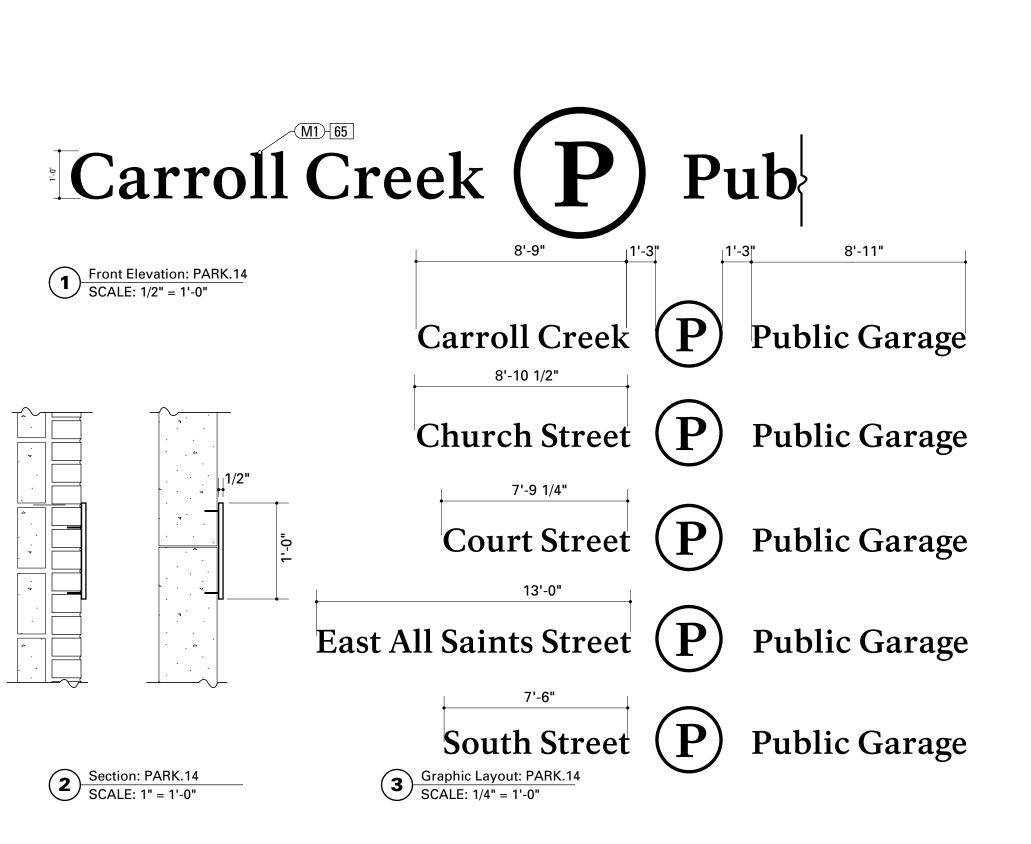


SPECIFICATIONS SIGN TYPE: PARK.14 FUNCTION: Parking Identification

65. LETTERS

Size: 1/2" Thk.
MATERIAL: Aluminum
FABRICATION PROCESS: Router Cut FabricatedEdges
EDGES: Smooth
FINISH: Horizontal Brushed
SURFACE PROCESS: Satin Clearcoat
FASTENER: mechanically fasten to existing wall. Anchor
suitable for wall material. Allowable shear capacity of
anchor = 10 lbs. (min). 3 Anchors per anchor, Stud Mount
Flush to wall surface.

- Fabricator to verify the mounting conditions and provide a detail drawing for each mounting situation, prior to fabrication.
 Fabricator must obtain approval from the Designer or Client for placement prior to fabrication.
- 2. Welds: All welds shall be ground smooth, paint all seams
- ${\it 3. \, Hardware: All \, exposed \, hardware \, shall \, be \, tamper \, proof \, fasteners.}$
- 4. All exposed edges painted to match adjacent face.

ENVIRONMENTS &	EXPERIENCES	CLIENT / PROJECT
merje	The Widener Building, Suite 1500 One South Penn Square Philadelphia, PA 19107 T 215.599.4407 F 215.636.9989	City of Frederick, MD Wayfinding & Signage Program
	www.merjedesign.com	PROJECT NO. Y41.07961.000
SUBCONSULTANT		SHEET TITLE
DATE 12/17/2008	DRAWN BY: GS/KG/KB	PARK.14
hese drawings are meant for DESIGN INTENT ONLY nd are not for construction. Contractor shall verify nd be responsible for all dimensions and conditions if the job. Contractor shall be familiar with the site	REVISIONS	Parking Letters
and conditions it presents. This office must be noti- ted of any variations from the dimensions and condi- ions shown on this drawing. Shop drawings and letails must be submitted to this office for approval rior to proceeding with fabrication. All copy shall be roofread by client and lead requirements checked		SHEET NO. D.23

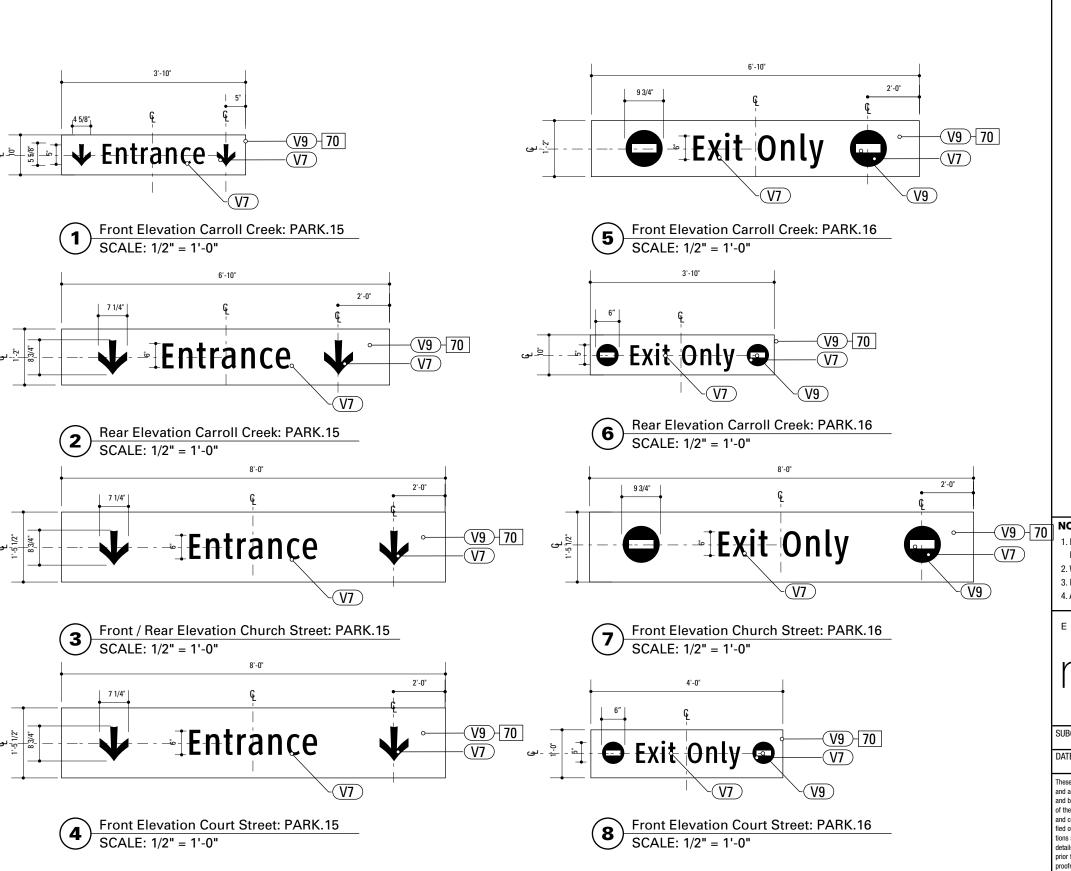

SPECIFICATIONS SIGN TYPE: PARK.15-16 FUNCTION: Parking Identification


70. SIGN FACE:


Size: Verfiy and Match existing Sign Sizes
MATERIAL: Acrylic
FABRICATION PROCESS: Router Cut FabricatedEdges
EDGES: Smooth
VINYL: 3M Scotchcal Translucent Graphic Film as specified

DIFFUSER: 3M Diffuser Film as specified SUBSTRATE: 3M Panaflex 945 as specified COLOR: As indicated in Color Chart

Contractor is to replace the sign face from the existing internally illuminated sign box. Fabricator is to verify all conditions and dimensions prior to fabrication. The Contractor is to also replicate the fabrication process ,materials and material sizes, so that the replacement of the sign face is exact.


- Fabricator to verify the mounting conditions and provide a detail drawing for each mounting situation, prior to fabrication.
 Fabricator must obtain approval from the Designer or Client for placement prior to fabrication.
- 2. Welds: All welds shall be ground smooth, paint all seams.
- 3. Hardware: All exposed hardware shall be tamper proof fasteners.
- 4. All exposed edges painted to match adjacent face.

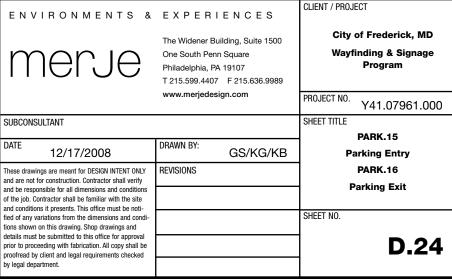


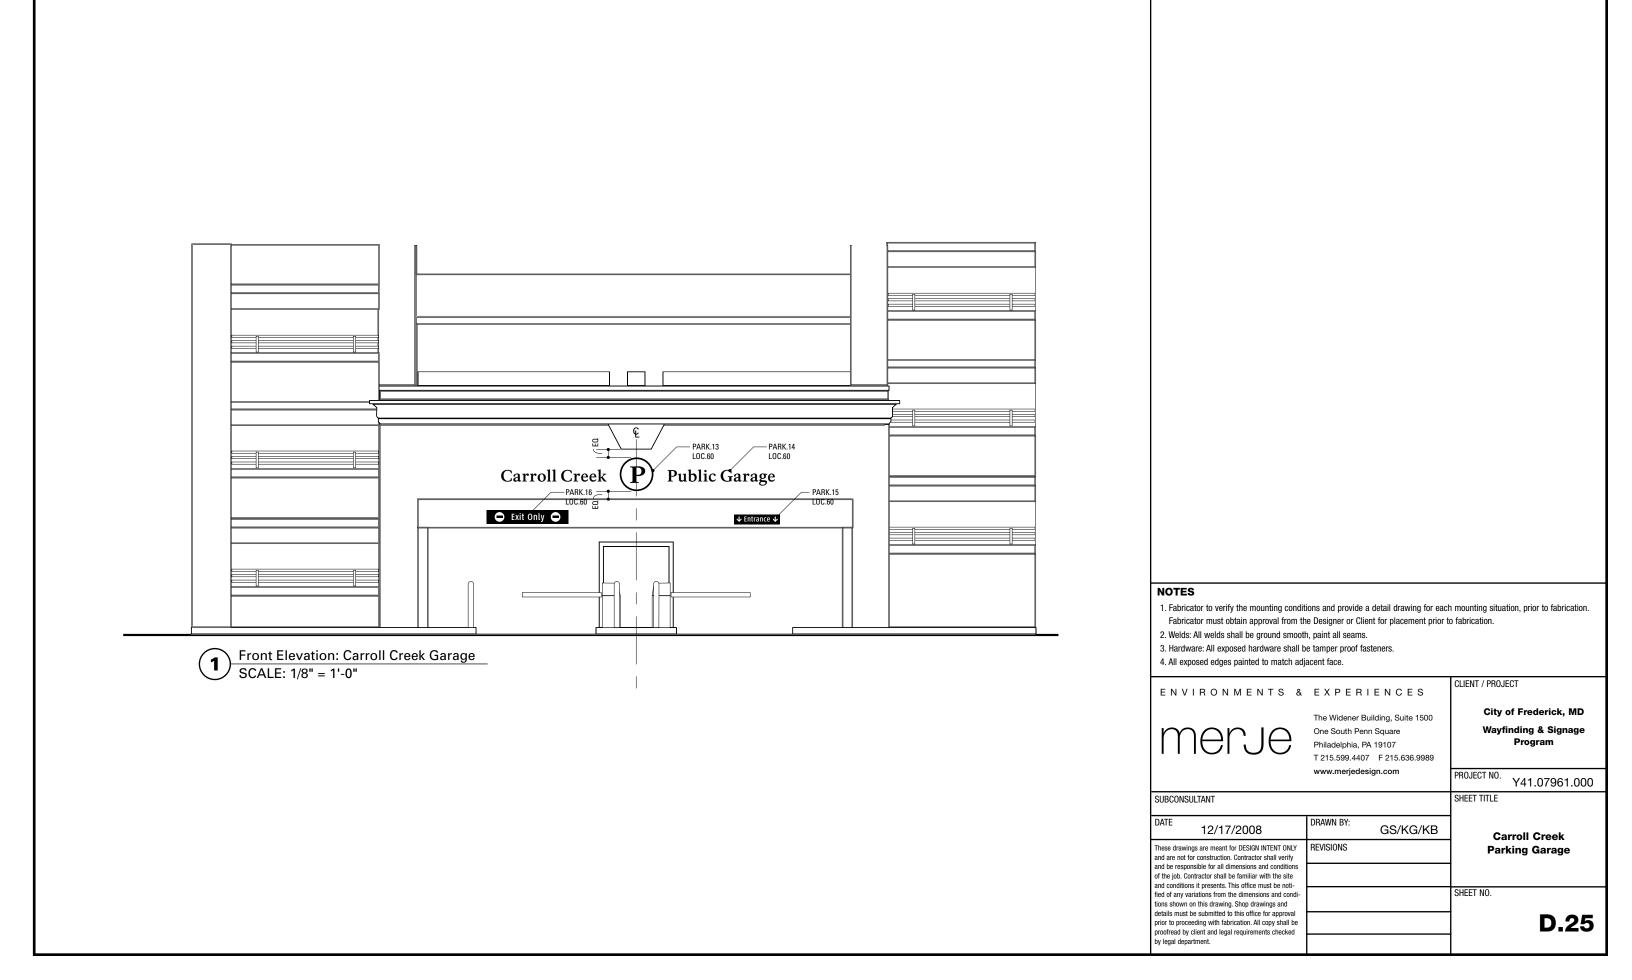


SIGN TYPE:


FUNCTION: Garage Signs

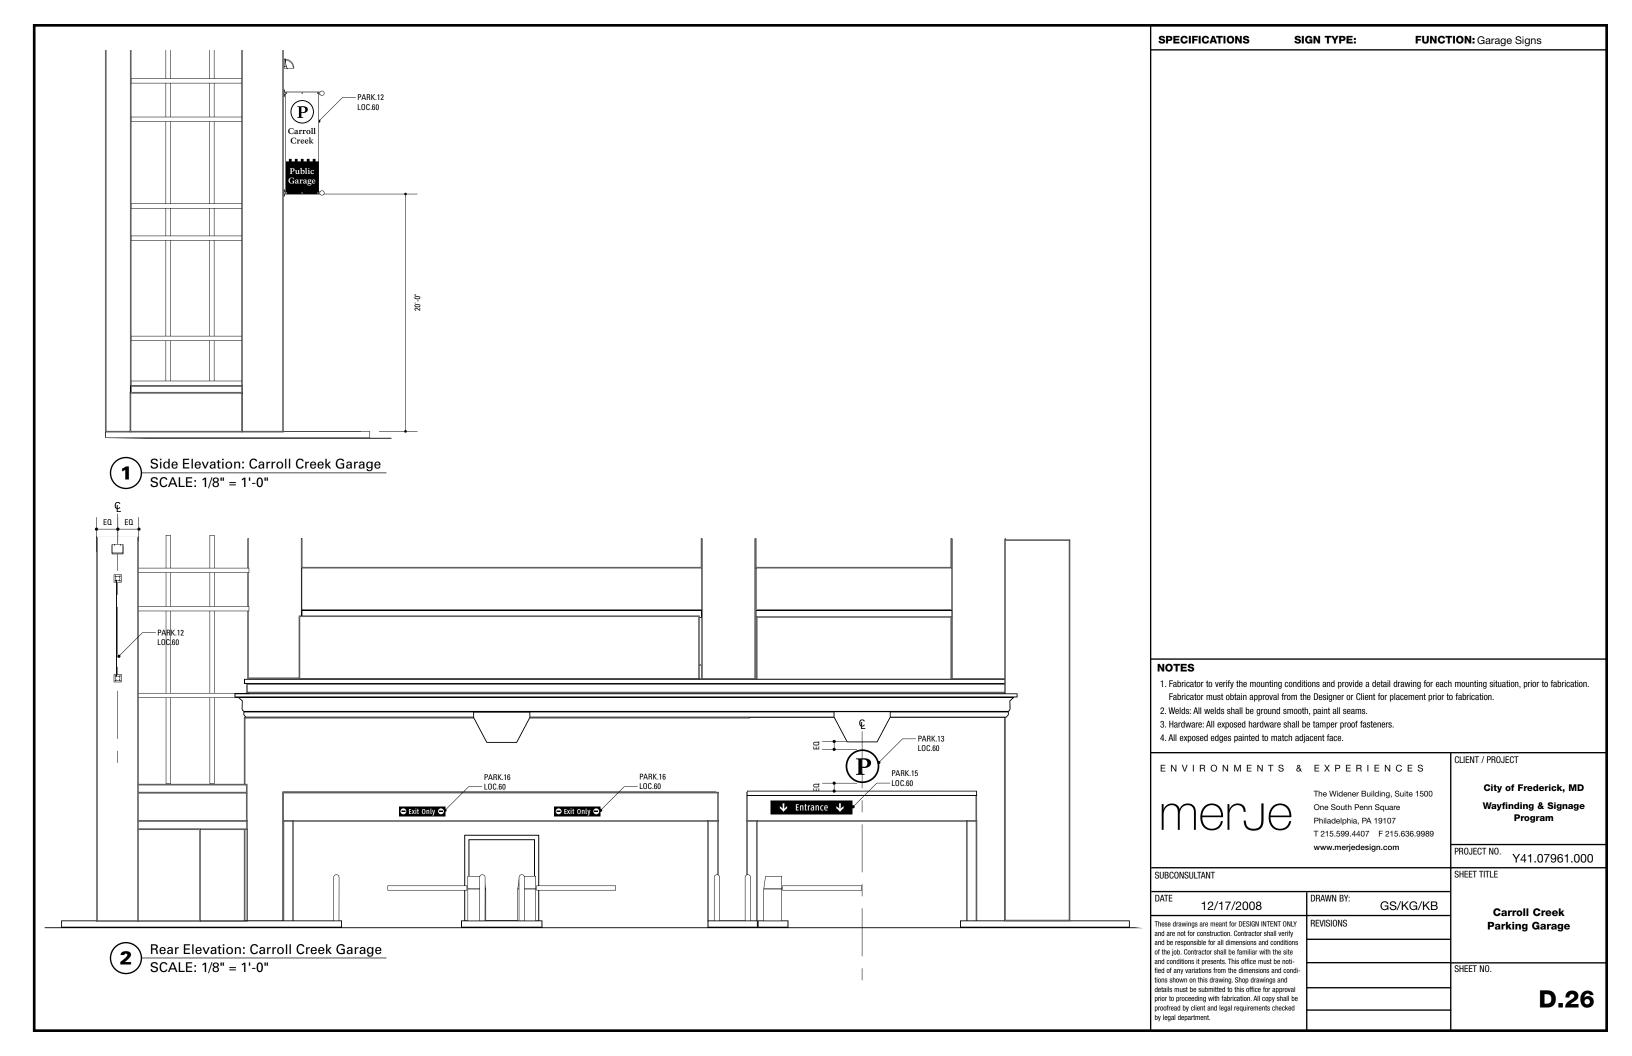


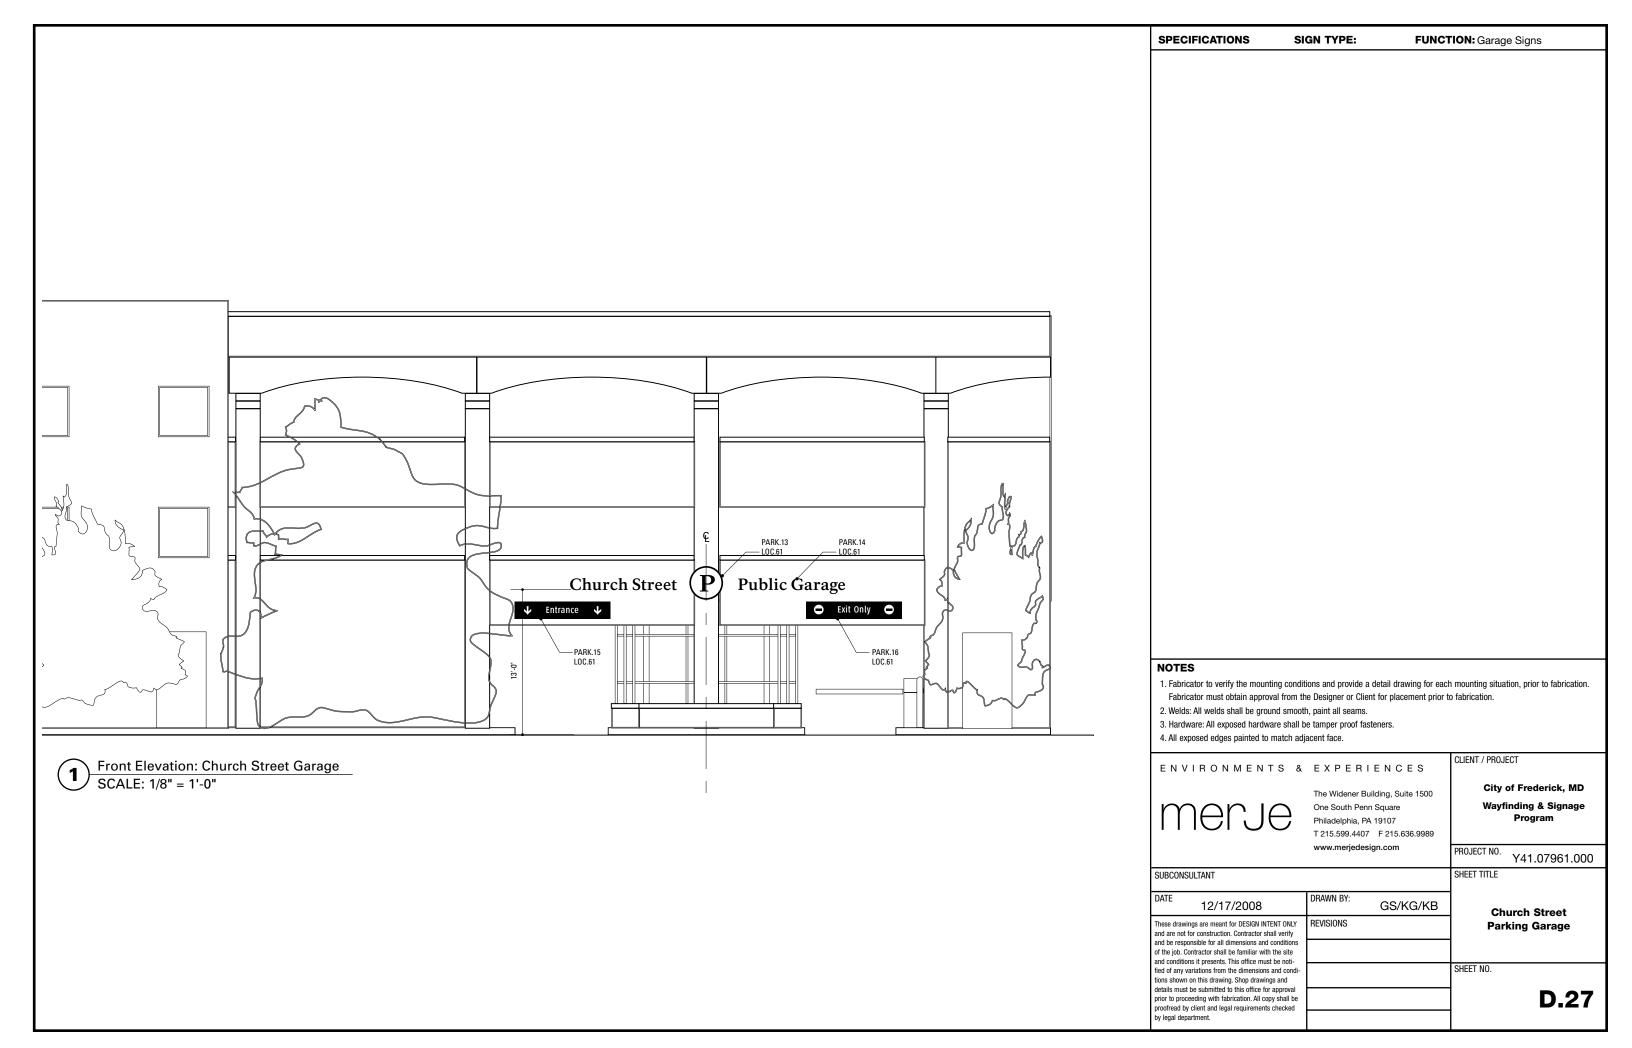


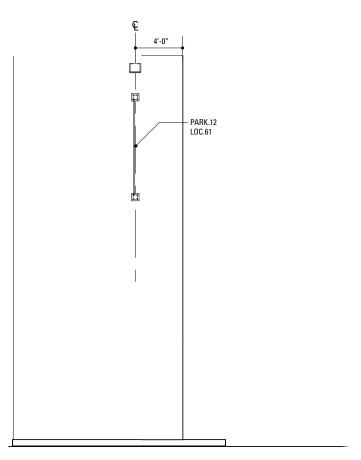


Side Elevation: Church Street Garage
SCALE: 1/8" = 1'-0"

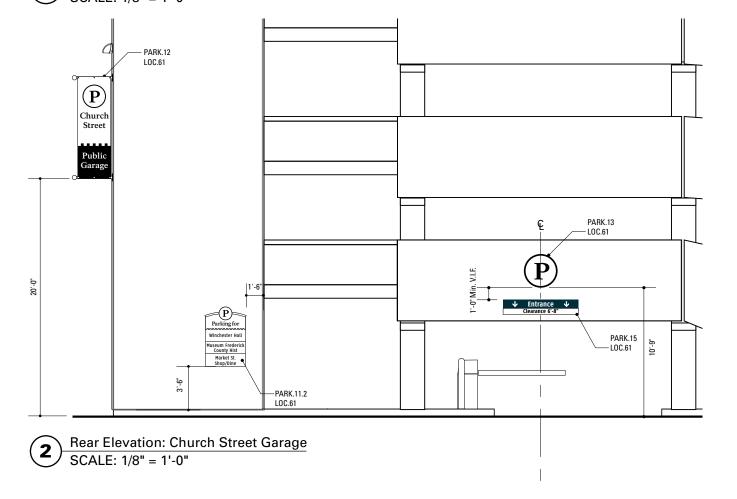


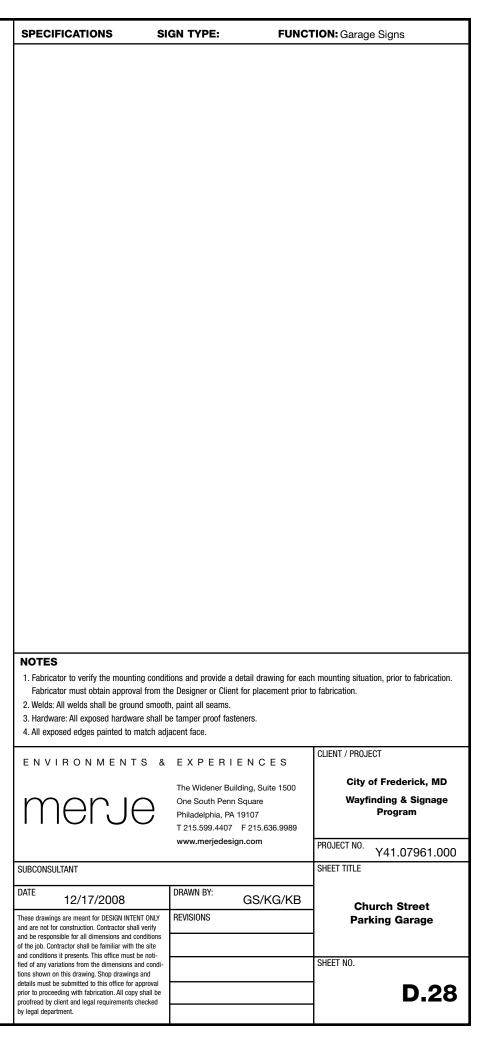

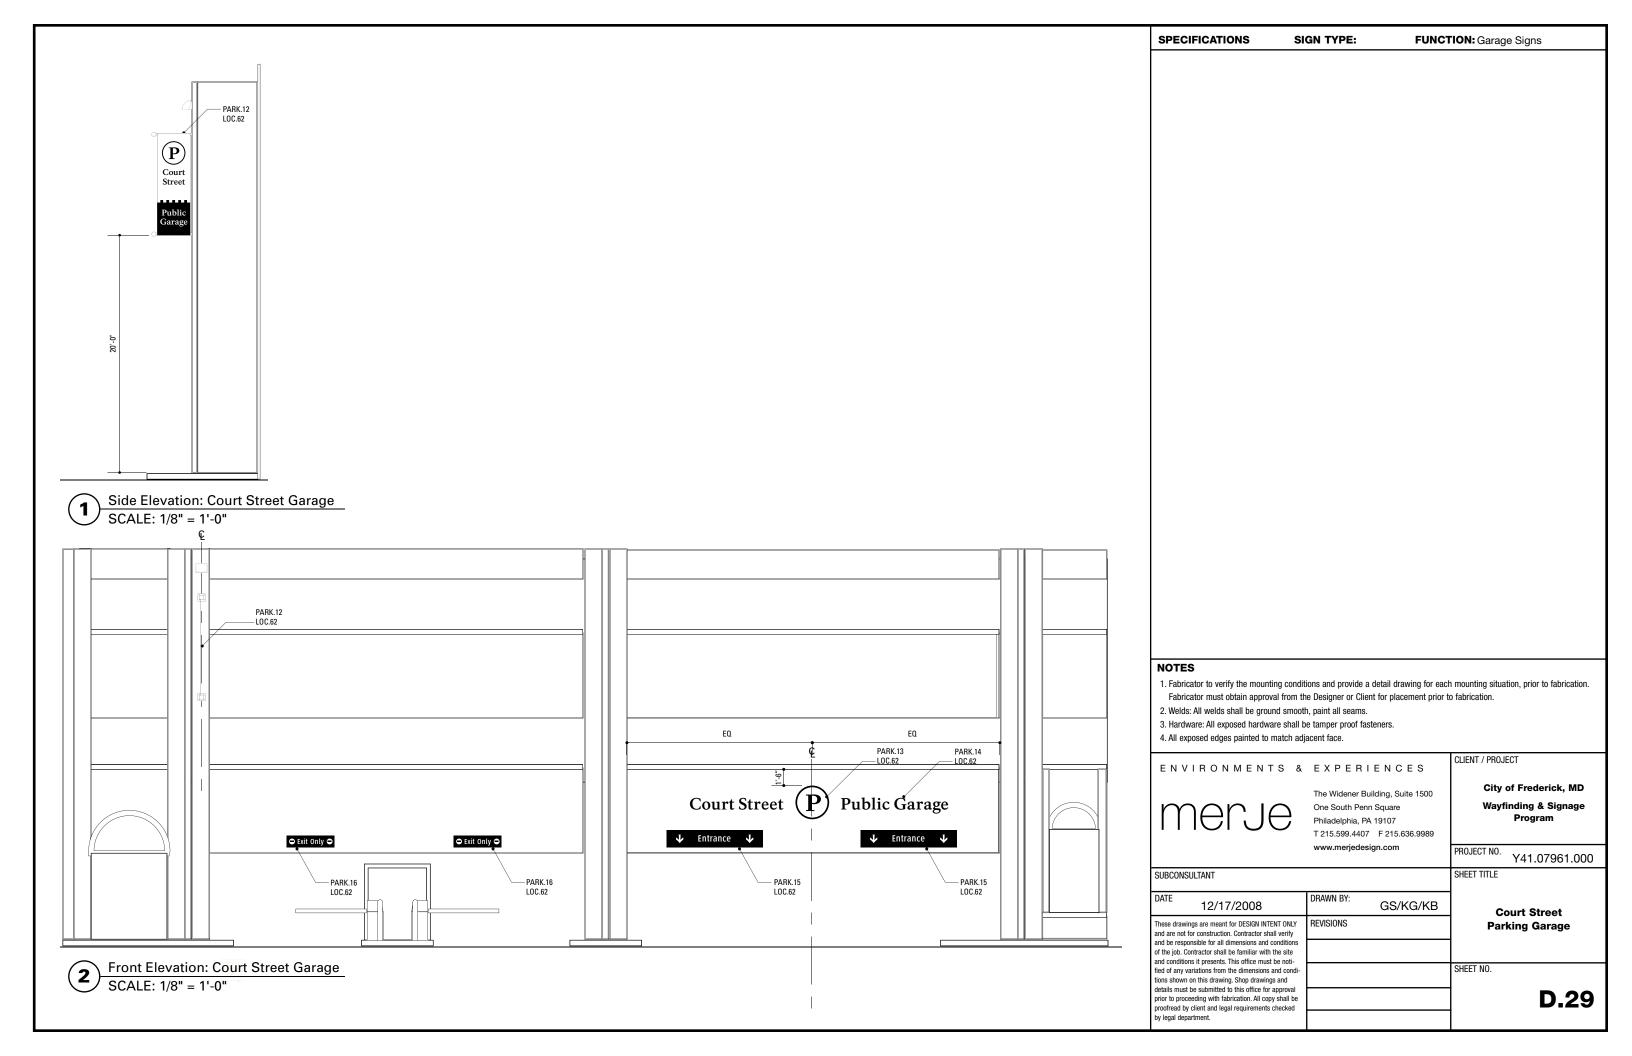

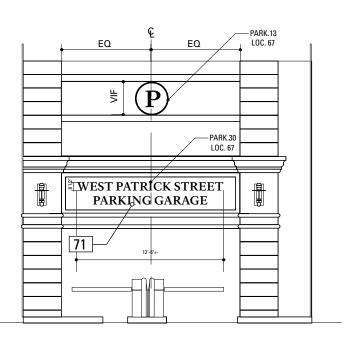

Front Elevation: West Patrick St. Garage SCALE: 1/8" = 1'-0"

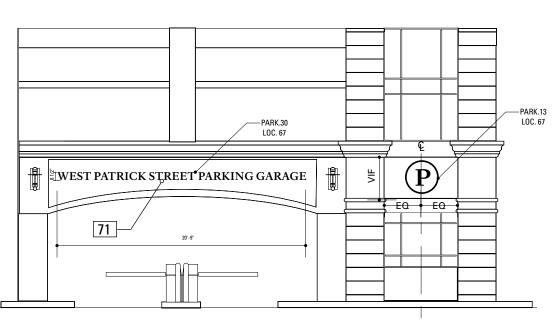

Rear Elevation: West Patrick St. Garage

SCALE: 1/8" = 1'-0"

SPECIFICATIONS

SIGN TYPE: PARK.30 **FUNCTION:** Filled Letters

70. EXISTING CARVED LETTERS
MATERIAL: Granite


FABRICATION PROCESS: Filled COLOR: Black

Contractor to be familiar with wall surface and provide a recommendation for the type of paint.

by legal department.

- 1. Fabricator to verify the mounting conditions and provide a detail drawing for each mounting situation, prior to fabrication. Fabricator must obtain approval from the Designer or Client for placement prior to fabrication.
- 2. Welds: All welds shall be ground smooth, paint all seams.
- 3. Hardware: All exposed hardware shall be tamper proof fasteners.
- 4. All exposed edges painted to match adjacent face.

ENVIRONMENTS &	EXPERI	ENCES	CLIENT / PROJ	ECT
merje	The Widener Building, Suite 1500 One South Penn Square Philadelphia, PA 19107 T 215.599.4407 F 215.636.9989		1	of Frederick, MD inding & Signage Program
	www.merjedesi	gn.com	PROJECT NO.	Y41.07961.000
SUBCONSULTANT			SHEET TITLE	
DATE 12/17/2008	DRAWN BY:	GS/KG/KB	Sign	Type PARK.30
These drawings are meant for DESIGN INTENT ONLY and are not for construction. Contractor shall verify	REVISIONS		West	Patrick Street Garage
and be responsible for all dimensions and conditions of the job. Contractor shall be familiar with the site and conditions it presents. This office must be noti-				
fied of any variations from the dimensions and condi- tions shown on this drawing. Shop drawings and			SHEET NO.	
details must be submitted to this office for approval prior to proceeding with fabrication. All copy shall be proofread by client and legal requirements checked				D.30
by legal department.	I		1	

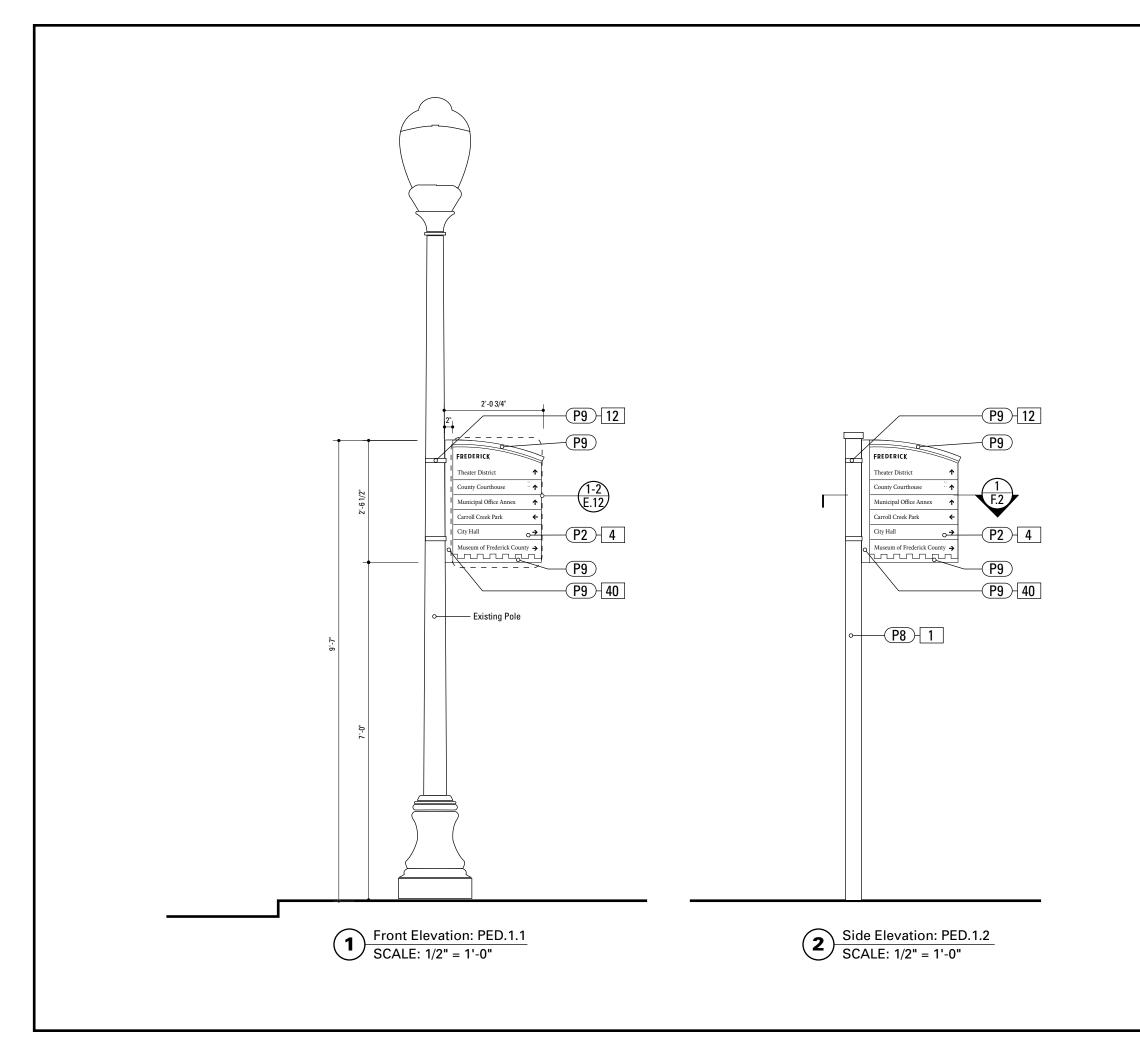

SPECIFICATIONS SIGN TYPE: PED1.1 FUNCTION: Pedestrian Directional

1. 4" ROUND POLE

MATERIAL: 4" dia, 1/4" thick Aluminum round tube FABRICATION PROCESS: Extruded / cut EDGES: Smooth COLOR: Custom, as noted SURFACE PROCESS: Paint all exposed surfaces FOOTER: TRANSPO Break-safe or MDOT approved equal. REFER TO SECTION G FOR FOOTERS CAP: Custom

4. SIGN PANEL MATERIAL: 1/4" thk Aluminum FABRICATION PROCESS: Contour Cut EDGES: Smooth COLOR: custom, as noted SURFACE PROCESS: Paint all exposed surfaces FASTENER: Continuous weld to sleeve

Vinyl Graphics applied to front face of Sign Panel. See Color Page for Specifications

12. BUCKLE BRACKET

PRODUCT: BAND-IT Band MATERIAL: Type 201 SS COLOR: Match existing pole SURFACE PROCESS: Paint all exposed surfaces FASTENER: Custom

40. SUPPORT CHANNEL EXTRUSION

PRODUCT: Custom MATERIAL: Aluminum FABRICATION PROCESS: Extruded FINISH: Standard SURFACE PROCESS: Paint all exposed surfaces FASTENER: Mech. Fasten to Sign Panel


NOTES

1. Fabricator to verify the mounting conditions and provide a detail drawing for each mounting situation, prior to fabrication. Fabricator must obtain approval from the Designer or Client for placement prior to fabrication.

CLIENT / PROJECT

- 2. Welds: All welds shall be ground smooth, paint all seams.
- 3. Hardware: All exposed hardware shall be tamper proof fasteners.
- 4. All exposed edges painted to match adjacent face.

ENVIRONMENTS &	EXPERIENCES	CLIENT / PROJECT
merje	The Widener Building, Suite 1500 One South Penn Square Philadelphia, PA 19107 T 215.599.4407 F 215.636.9989	City of Frederick, MD Wayfinding & Signage Program
	www.merjedesign.com	PROJECT NO. Y41.07961.000
SUBCONSULTANT		SHEET TITLE
DATE 12/17/2008	DRAWN BY: GS/KG/KB	PED.1.1 / PED.2.1
These drawings are meant for DESIGN INTENT ONLY and are not for construction. Contractor shall verify	REVISIONS	Pedestrian Directional
		Pedestrian Directional
and be responsible for all dimensions and conditions of the job. Contractor shall be familiar with the site		Pedestrian Directional
and be responsible for all dimensions and conditions		SHEET NO.
and be responsible for all dimensions and conditions of the job. Contractor shall be familiar with the site and conditions it presents. This office must be notified of any variations from the dimensions and condi-		

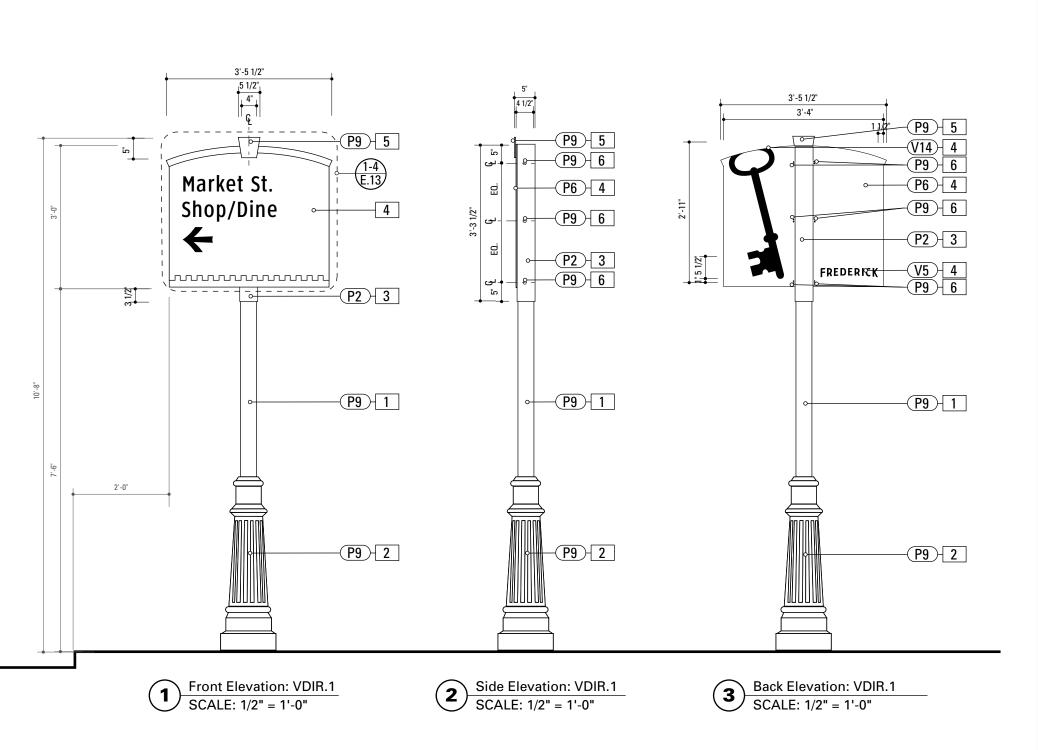

SPECIFICATIONS SIGN TYPE: VDIR.1 FUNCTION: Vehicular Directional

1. 4" ROUND POLE

MATERIAL: 4" dia, 1/4" thick Aluminum round tube FABRICATION PROCESS: Extruded / cut EDGES: Smooth COLOR: Custom, as noted SURFACE PROCESS: Paint all exposed surfaces FOOTER: TRANSPO Break-safe or MDOT approved equal. REFER TO SECTION G FOR FOOTERS

2. DECORATIVE CLAMSHELL BASE

PRODUCT: Hapco Homewood Two-Piece Base (HOC), 4" butt diameter, 7 1/2" diameter base EDGES: Smooth COLOR: Custom, as noted SURFACE PROCESS: Paint all exposed surfaces FASTENER: Mechanically fastened around 4" pole

3. SLEEVE

MATERIAL: 1/4" thk Aluminum square tube FABRICATION PROCESS: Extruded / cut EDGES: Smooth COLOR: custom, as noted SURFACE PROCESS: Paint all exposed surfaces FASTENER: Mechanically fastened to pole

4. SIGN PANEL

MATERIAL: 1/4" thk Aluminum
FABRICATION PROCESS: Contour Cut
EDGES: Smooth
COLOR: custom, as noted
SURFACE PROCESS: Paint all exposed surfaces
FASTENER: Continuous weld to sleeve

Vinyl Graphics applied to front face of Sign Panel. See Color Page for Specifications

5. KEYSTONE

MATERIAL: 1/4" thk Aluminum
FABRICATION PROCESS: Contour Cut
EDGES: Smooth
COLOR: custom, as noted
SURFACE PROCESS: Paint all exposed surfaces
FASTENER: Chemical weld to sign panel

6. EXPOSED FASTENER

PRODUCT: Heavy Hex Head Bolt SIZE: As required MATERIAL: Stainless Steel FINISH: Painted COLOR: custom, as noted SURFACE PROCESS: Paint all exposed surfaces

NOTES

- 1. Fabricator to verify the mounting conditions and provide a detail drawing for each mounting situation, prior to fabrication. Fabricator must obtain approval from the Designer or Client for placement prior to fabrication.
- 2. Welds: All welds shall be ground smooth, paint all seams
- 3. Hardware: All exposed hardware shall be tamper proof fasteners.

ENVIRONMENTS & EXPERIENCES


4. All exposed edges painted to match adjacent face.

prior to proceeding with fabrication. All copy shall be proofread by client and legal requirements checked

by legal department.

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	www.merjedesi	gn.com	PROJECT NO.	Y41.07961.000
SUBCONSULTANT			SHEET TITLE	
DATE 12/17/2008	DRAWN BY:	GS/KG/KB		VDIR.1
These drawings are meant for DESIGN INTENT ONLY and are not for construction. Contractor shall verify	REVISIONS		Vehic	ular Directional
and be responsible for all dimensions and conditions of the job. Contractor shall be familiar with the site			1	
and conditions it presents. This office must be noti- fied of any variations from the dimensions and condi- tions shown on this drawing. Shop drawings and			SHEET NO.	

CLIENT / PROJECT

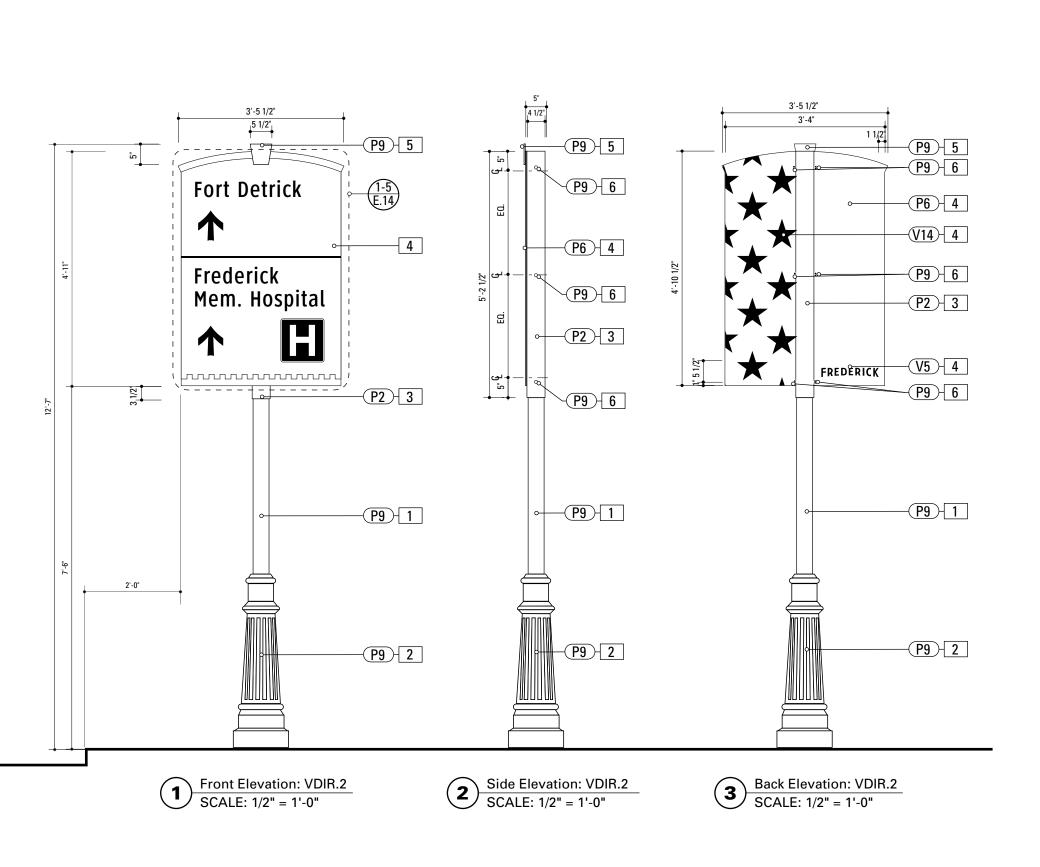

SPECIFICATIONS SIGN TYPE: VDIR.2 **FUNCTION:** Vehicular Directional

1. 4" ROUND POLE

MATERIAL: 4" dia, 1/4" thick Aluminum round tube FABRICATION PROCESS: Extruded / cut EDGES: Smooth COLOR: Custom, as noted SURFACE PROCESS: Paint all exposed surfaces FOOTER: TRANSPO Break-safe or MDOT approved equal. REFER TO SECTION G FOR FOOTERS

2. DECORATIVE CLAMSHELL BASE

PRODUCT: Hapco Homewood Two-Piece Base (HOC), 4" butt diameter, 7 1/2" diameter base FDGFS: Smooth COLOR: Custom, as noted SURFACE PROCESS: Paint all exposed surfaces FASTENER: Mechanically fastened around 4" pole

3. SLEEVE

MATERIAL: 1/4" thk Aluminum square tube FABRICATION PROCESS: Extruded / cut EDGES: Smooth COLOR: custom, as noted SURFACE PROCESS: Paint all exposed surfaces FASTENER: Mechanically fastened to pole

SIGN PANEL

MATERIAL: 1/4" thk Aluminum FABRICATION PROCESS: Contour Cut EDGES: Smooth COLOR: custom, as noted SURFACE PROCESS: Paint all exposed surfaces FASTENER: Continuous weld to sleeve

Vinyl Graphics applied to front face of Sign Panel. See Color Page for Specifications

KEYSTONE

MATERIAL: 1/4" thk Aluminum FABRICATION PROCESS: Contour Cut EDGES: Smooth COLOR: custom, as noted SURFACE PROCESS: Paint all exposed surfaces FASTENER: Chemical weld to sign panel

6. EXPOSED FASTENER

PRODUCT: Heavy Hex Head Bolt SIZE: As required MATERIAL: Stainless Steel FINISH: Painted COLOR: custom, as noted SURFACE PROCESS: Paint all exposed surfaces

NOTES

by legal department.

- 1. Fabricator to verify the mounting conditions and provide a detail drawing for each mounting situation, prior to fabrication. Fabricator must obtain approval from the Designer or Client for placement prior to fabrication.
- 2. Welds: All welds shall be ground smooth, paint all seams
- 3. Hardware: All exposed hardware shall be tamper proof fasteners.


ENVIRONMENTS & EXPERIENCES

4. All exposed edges painted to match adjacent face.

prior to proceeding with fabrication. All copy shall be proofread by client and legal requirements checked

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SUBCONSULTANT		SHEET TITLE
DATE 12/17/2008	DRAWN BY: GS/KG/KB	VDIR.2
These drawings are meant for DESIGN INTENT ONLY and are not for construction. Contractor shall verify	REVISIONS	Vehicular Directional
and be responsible for all dimensions and conditions of the job. Contractor shall be familiar with the site and conditions it presents. This office must be noti-		
fied of any variations from the dimensions and condi- tions shown on this drawing. Shop drawings and		SHEET NO.

CLIENT / PROJECT

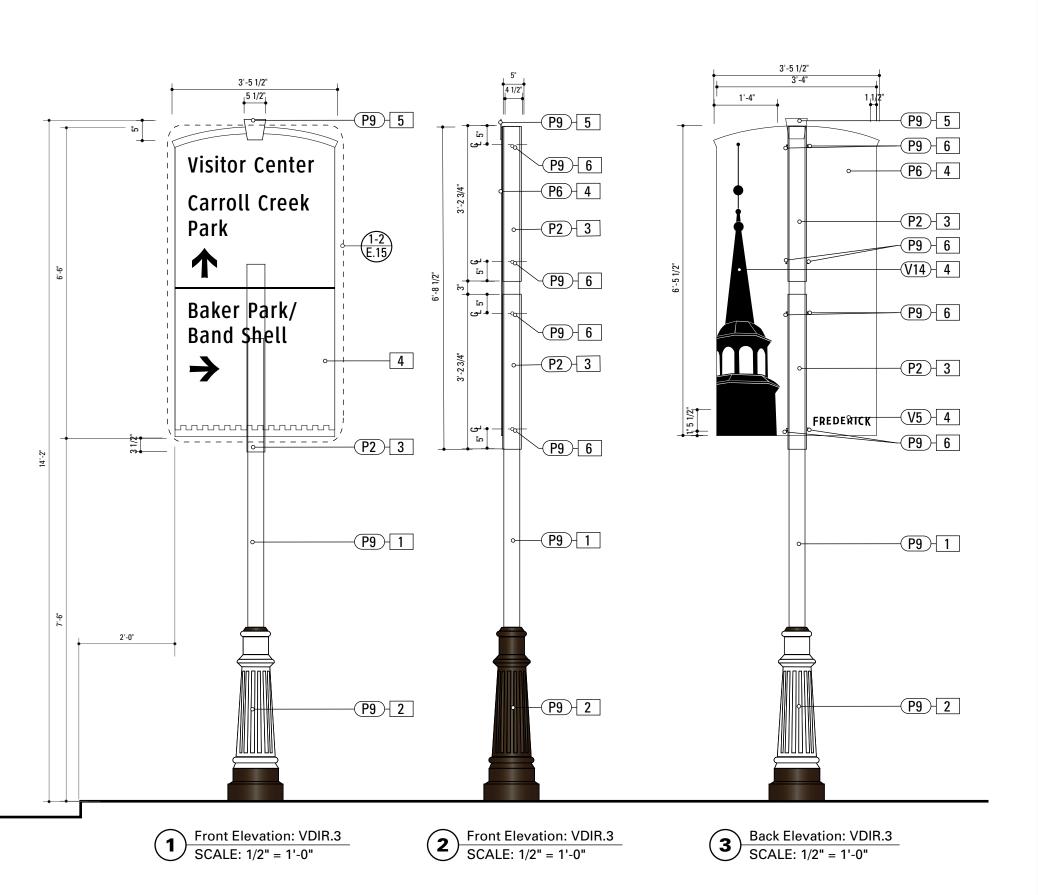

SPECIFICATIONS SIGN TYPE: VDIR.3 FUNCTION: Vehicular Directional

1. 4" ROUND POLE

MATERIAL: 4" dia, 1/4" thick Aluminum round tube FABRICATION PROCESS: Extruded / cut EDGES: Smooth COLOR: Custom, as noted SURFACE PROCESS: Paint all exposed surfaces FOOTER: TRANSPO Break-safe or MDOT approved equal. REFER TO SECTION G FOR FOOTERS

2. DECORATIVE CLAMSHELL BASE

PRODUCT: Hapco Homewood Two-Piece Base (H0C), 4" butt diameter, 7 1/2" diameter base EDGES: Smooth COLOR: Custom, as noted SURFACE PROCESS: Paint all exposed surfaces FASTENER: Mechanically fastened around 4" pole

3. SLEEVE

MATERIAL: 1/4" thk Aluminum square tube FABRICATION PROCESS: Extruded / cut EDGES: Smooth COLOR: custom, as noted SURFACE PROCESS: Paint all exposed surfaces FASTENER: Mechanically fastened to pole

4. SIGN PANEL

MATERIAL: 1/4" thk Aluminum
FABRICATION PROCESS: Contour Cut
EDGES: Smooth
COLOR: custom, as noted
SURFACE PROCESS: Paint all exposed surfaces
FASTENER: Continuous weld to sleeve

Vinyl Graphics applied to front face of Sign Panel. See Color Page for Specifications

5. KEYSTONE

MATERIAL: 1/4" thk Aluminum
FABRICATION PROCESS: Contour Cut
EDGES: Smooth
COLOR: custom, as noted
SURFACE PROCESS: Paint all exposed surfaces
FASTENER: Chemical weld to sign panel

6. EXPOSED FASTENER

PRODUCT: Heavy Hex Head Bolt SIZE: As required MATERIAL: Stainless Steel FINISH: Painted COLOR: custom, as noted SURFACE PROCESS: Paint all exposed surfaces


NOTES


- 1. Fabricator to verify the mounting conditions and provide a detail drawing for each mounting situation, prior to fabrication. Fabricator must obtain approval from the Designer or Client for placement prior to fabrication.
- $2.\,Welds: All\,\,welds\,\,shall\,\,be\,\,ground\,\,smooth,\,paint\,\,all\,\,seams.$
- 3. Hardware: All exposed hardware shall be tamper proof fasteners.
- 4. All exposed edges painted to match adjacent face.


prior to proceeding with fabrication. All copy shall be proofread by client and legal requirements checked


by legal department.

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UBCONSULTANT		SHEET TITLE
ATE 12/17/2008	DRAWN BY: GS/KG/KB	VDIR.3
nese drawings are meant for DESIGN INTENT ONLY and are not for construction. Contractor shall verify	REVISIONS	Vehicular Directional
nd be responsible for all dimensions and conditions the job. Contractor shall be familiar with the site and conditions it presents. This office must be noti-		
ed of any variations from the dimensions and condi- ons shown on this drawing. Shop drawings and		SHEET NO.

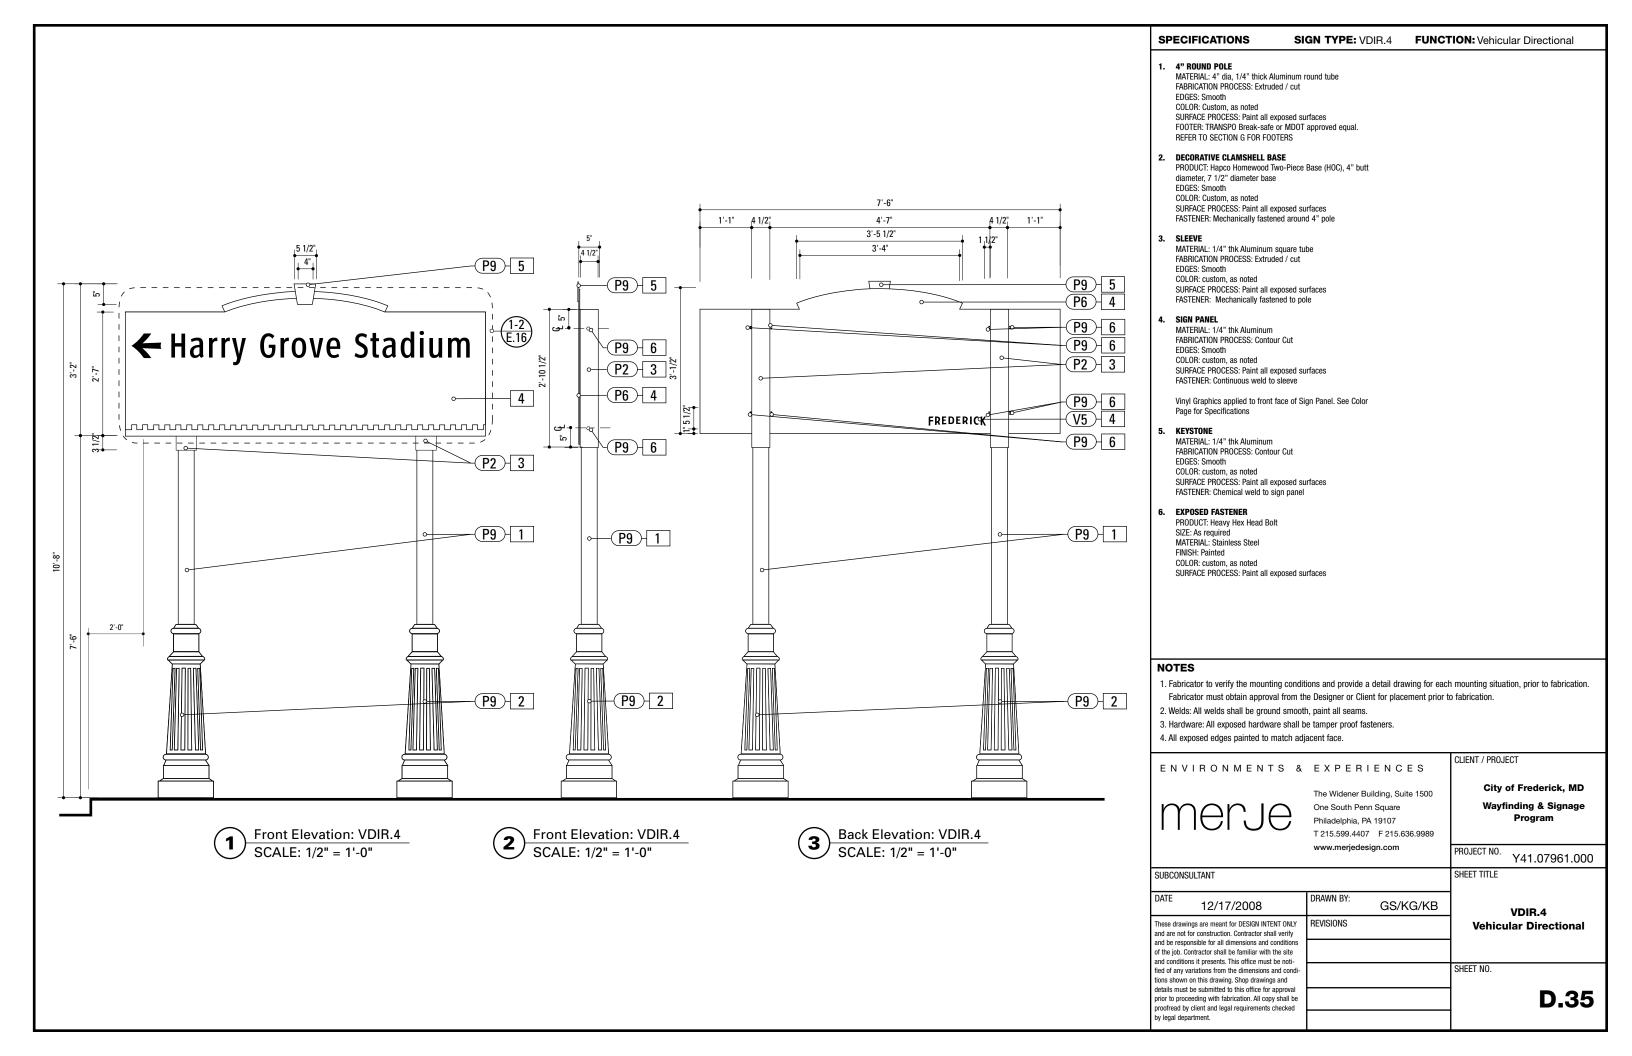

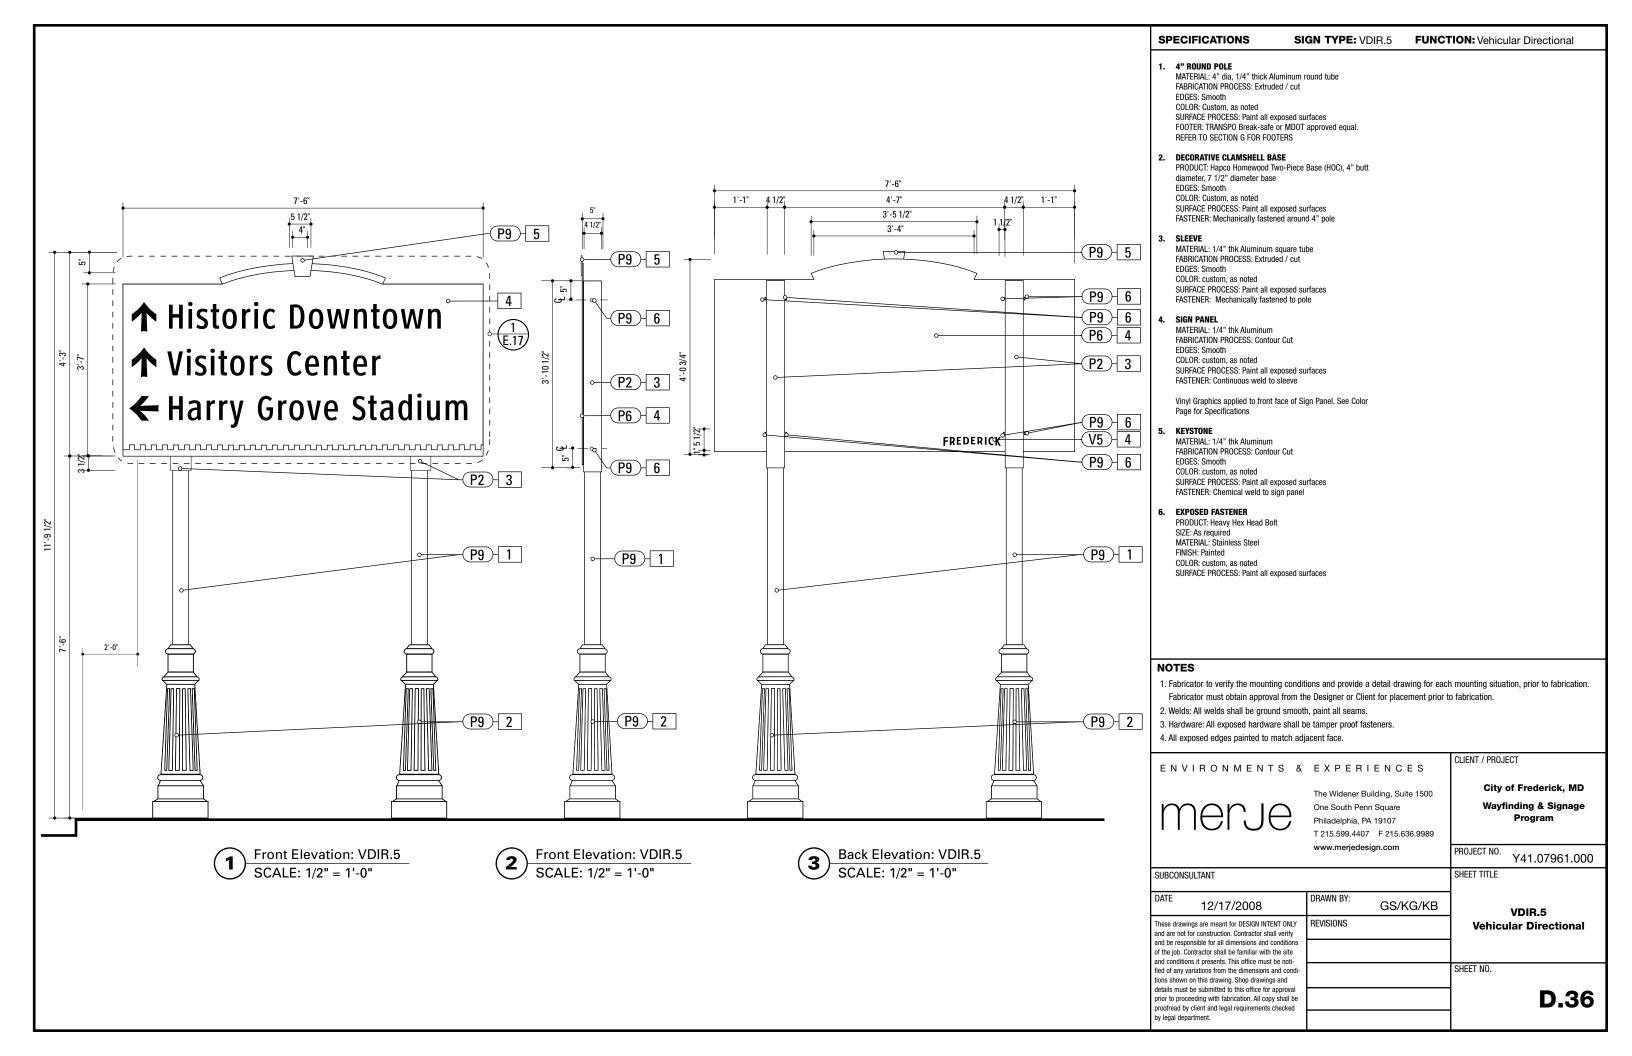

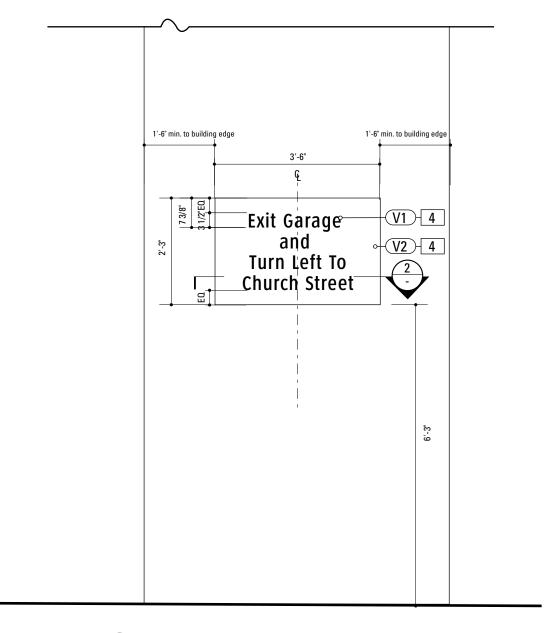

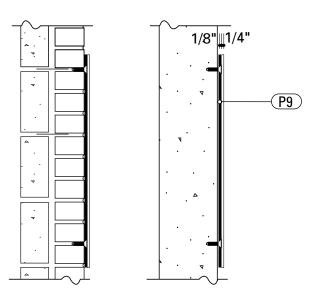

Front Elevation: PARK.25

SCALE: 1/2" = 1'-0"

Section: PARK.25

SCALE: 1" = 1'-0"

SPECIFICATIONS SIGN TYPE: PARK.25 FUNCTION: Parking Directional

4. SIGN PANEL

MATERIAL: 1/4" thk Aluminum FABRICATION PROCESS: Square Cut EDGES: Smooth

COLOR: custom, as noted SURFACE PROCESS: Paint all exposed surfaces

FASTENER: Chemically Welded to Backer Panel

BACKER PANEL

MATERIAL: 1/8" thk Aluminum

FABRICATION PROCESS: Square Cut to match dimensions of sign panel

EDGES: Smooth

COLOR: custom, as noted

SURFACE PROCESS: Paint all exposed surfaces FASTENER: mechanically fasten to existing wall. Anchor suitable for wall material. Allowable shear capacity of anchor = 50 lbs. (min). 8 Anchors, with 1 anchor placed

at each corner. Stud Mount Welded or countersunk to sign panel.

COPY ARROW RULE BACKGROUND

PRODUCT: 3M Engineer Grade reflective sheeting MATERIAL: vinyl FABRICATION PROCESS: Electronically cut / Applied


COLOR: custom, as noted

NOTES

by legal department.

- Fabricator to verify the mounting conditions and provide a detail drawing for each mounting situation, prior to fabrication.
 Fabricator must obtain approval from the Designer or Client for placement prior to fabrication.
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- 3. Hardware: All exposed hardware shall be tamper proof fasteners.
- 4. All exposed edges painted to match adjacent face.

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SUBCONSULTANT		SHEET TITLE
DATE 12/17/2008	DRAWN BY: GS/KG/KB	PARK.25
These drawings are meant for DESIGN INTENT ONLY and are not for construction. Contractor shall verify	REVISIONS	Parking Directional
and be responsible for all dimensions and conditions of the job. Contractor shall be familiar with the site and conditions it presents. This office must be noti-		
fied of any variations from the dimensions and condi- tions shown on this drawing. Shop drawings and		SHEET NO.
details must be submitted to this office for approval prior to proceeding with fabrication. All copy shall be proofread by client and legal requirements checked		D.37

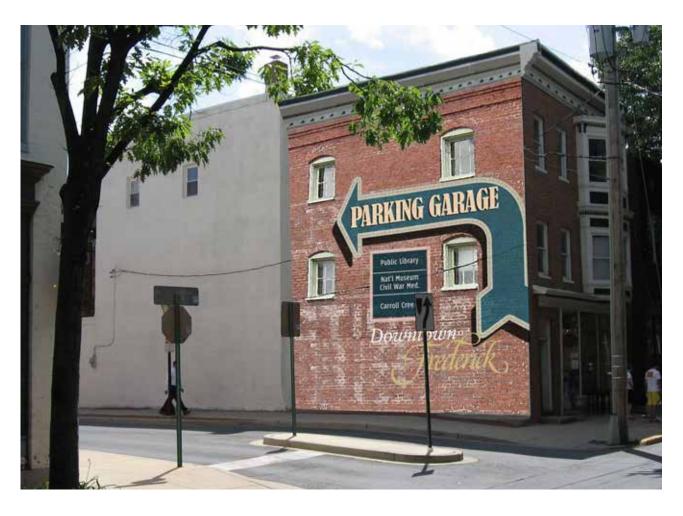



SIGN TYPE: MURAL.1 FUNCTION: Wall Mural

Painted Wall Mural

Style: Trompe L'Oeil
Surface: Existing Brick
Size: 40ft x 30ft
Note: Artwork Shown for Style and
Content only. The Artist is to provide
an example proof for client review and
approval.

Code Of Practice

- 1. At all times so order their conduct as to uphold the integrity, and to carry out work in accordance with good practice and recognized standards, of the painting and decorating industry and pay particular regard to the maintenance and observance of this Code.
- 2. Contractor shall submit a written quotation for work to be undertaken, unless the work is of such intricate a nature as to preclude the submission of a fair quotation; in such cases, it should be pointed out to the client that it would be to the advantage of both parties if the work were to be carried out on a day work basis. (ii) In such cases, prior to the commencement of any work, the client should be informed of the day work rates for labour and materials; daywork sheets and/or fully costed timesheets should be presented to the client if so requested.(iii) A member firm shall be under no obligation to submit an estimate merely for establishing the value of an insurance or other claim; but if an estimate is submitted for such purpose, a fee may be charged therefor.(iv) Any quotation submitted shall be fair to both parties and shall be such as to yield a reasonable profit for a fair job.
- 3. Contractor shall so conduct its business that all work shall be executed by


competent workmen and apprentices under proper supervision. Employees shall be paid fair wages in accordance with rates agreed. A member firm shall, if so requested, make recommendations as to the materials to be used, such materials to be of good quality and to be used in accordance with the makers' recommendations.


- 4. Contractor shall arrange, and at all times maintain, adequate insurance cover in respect of employers' liability, public liability and any such other liability risks as may be determined necessary by the type of work undertaken.
- 5. Contractor shall always recommend to the client a method of treatment which will give a good and lasting job. When working to a specification, the terms thereof shall be faithfully carried out. When asked to recommend a specification, a member firm shall recommend one which shall be adequate for its purpose.(ii) The attention of the client or his representative shall be drawn to any apparent shortcomings which exist in a specification, but no responsibility will be accepted for work which the client has requested to be carried out in direct conflict with the member firm's professional advice.(iii) Having complied with clause 5.(ii), no member firm shall have any responsibility for an inadequate specification prepared by a professional architect or surveyor.
- 6 Contractor shall guarantee its work against failures due to its defective workmanship for a period of six months from the date of completion of the work.
- 7 Contractor shall comply with the regulations of the City of Frederick

- Fabricator to verify the mounting conditions and provide a detail drawing for each mounting situation, prior to fabrication.
 Fabricator must obtain approval from the Designer or Client for placement prior to fabrication.
- 2. Welds: All welds shall be ground smooth, paint all seams.
- 3. Hardware: All exposed hardware shall be tamper proof fasteners.
- 4. All exposed edges painted to match adjacent face.

ENVIRONMENTS &	EXPERIENCES	CLIENT / PROJECT
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SUBCONSULTANT		SHEET TITLE
DATE 12/17/2008	DRAWN BY: GS/KG/KB	MURAL.1
These drawings are meant for DESIGN INTENT ONLY and are not for construction. Contractor shall verify and be responsible for all dimensions and conditions of the job. Contractor shall be familiar with the site	REVISIONS	Wall Mural
and conditions it presents. This office must be notified of any variations from the dimensions and condi-		SHEET NO.
tions shown on this drawing. Shop drawings and details must be submitted to this office for approval prior to proceeding with fabrication. All copy shall be proofread by client and legal requirements checked		D.38

E. Graphic Layouts

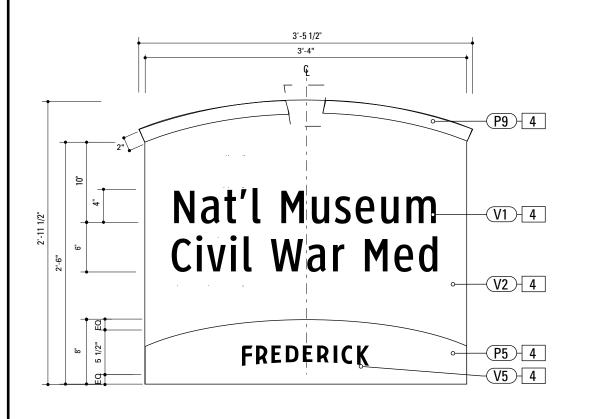

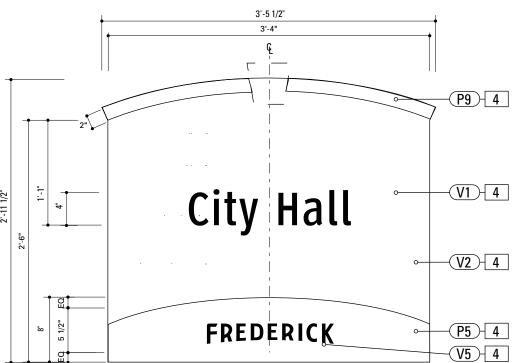

Graphic Layout: DEST.1

SCALE: 1" = 1'-0"



Graphic Layout: DEST.1
SCALE: 1" = 1'-0"

Graphic Layout: DEST.1

SCALE: 1" = 1'-0"

4. SIGN PANEL

MATERIAL: 1/4" thk Aluminum
FABRICATION PROCESS: Contour Cut
EDGES: Smooth
COLOR: custom, as noted
SURFACE PROCESS: Paint all exposed surfaces

FASTENER: Continuous weld to sleeve

Vinyl Graphics applied to front face of Sign Panel. See Color

SIGN TYPE: DEST.1


FUNCTION: Destination ID

Page for Specifications

SPECIFICATIONS

- 1. Fabricator to verify the mounting conditions and provide a detail drawing for each mounting situation, prior to fabrication. Fabricator must obtain approval from the Designer or Client for placement prior to fabrication.
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UBCONSULTANT		SHEET TITLE
ATE 12/17/2008	DRAWN BY: GS/KG/KB	DEST.1
hese drawings are meant for DESIGN INTENT ONLY nd are not for construction. Contractor shall verify	REVISIONS	Graphic Layout
nd be responsible for all dimensions and conditions f the job. Contractor shall be familiar with the site nd conditions it presents. This office must be noti-		
ed of any variations from the dimensions and condi- ons shown on this drawing. Shop drawings and		SHEET NO.
etails must be submitted to this office for approval		E.1
roofread by client and legal requirements checked		1

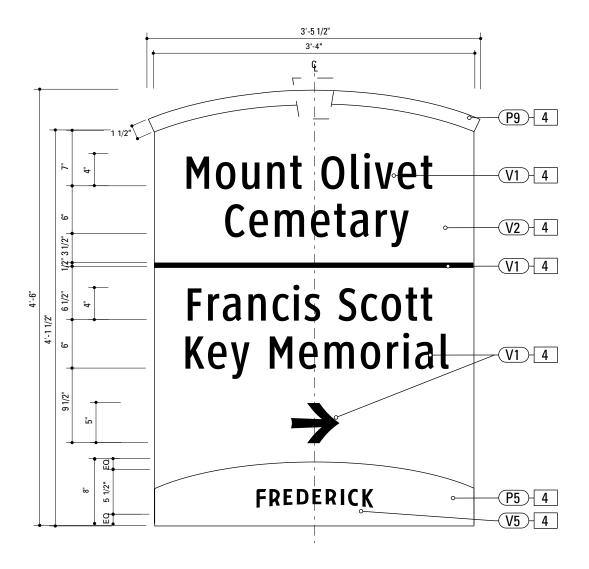

Graphic Layout: DEST.2

SCALE: 1" = 1'-0"

SPECIFICATIONS SIGN TYPE: DEST.2 **FUNCTION:** Arrival Sign


4. SIGN PANEL

MATERIAL: 1/4" thk Aluminum
FABRICATION PROCESS: Contour Cut
EDGES: Smooth
COLOR: custom, as noted
SURFACE PROCESS: Paint all exposed surfaces
FASTENER: Continuous weld to sleeve

Vinyl Graphics applied to front face of Sign Panel. See Color Page for Specifications

- Fabricator to verify the mounting conditions and provide a detail drawing for each mounting situation, prior to fabrication.
 Fabricator must obtain approval from the Designer or Client for placement prior to fabrication.
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SUBCONSULTANT		SHEET TITLE
DATE 12/17/2008	DRAWN BY: GS/KG/KB	DEST.2
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and be responsible for all dimensions and conditions of the job. Contractor shall be familiar with the site and conditions it presents. This office must be noti-		
fied of any variations from the dimensions and condi- tions shown on this drawing. Shop drawings and		SHEET NO.
details must be submitted to this office for approval prior to proceeding with fabrication. All copy shall be		E.2
proofread by client and legal requirements checked by legal department.		

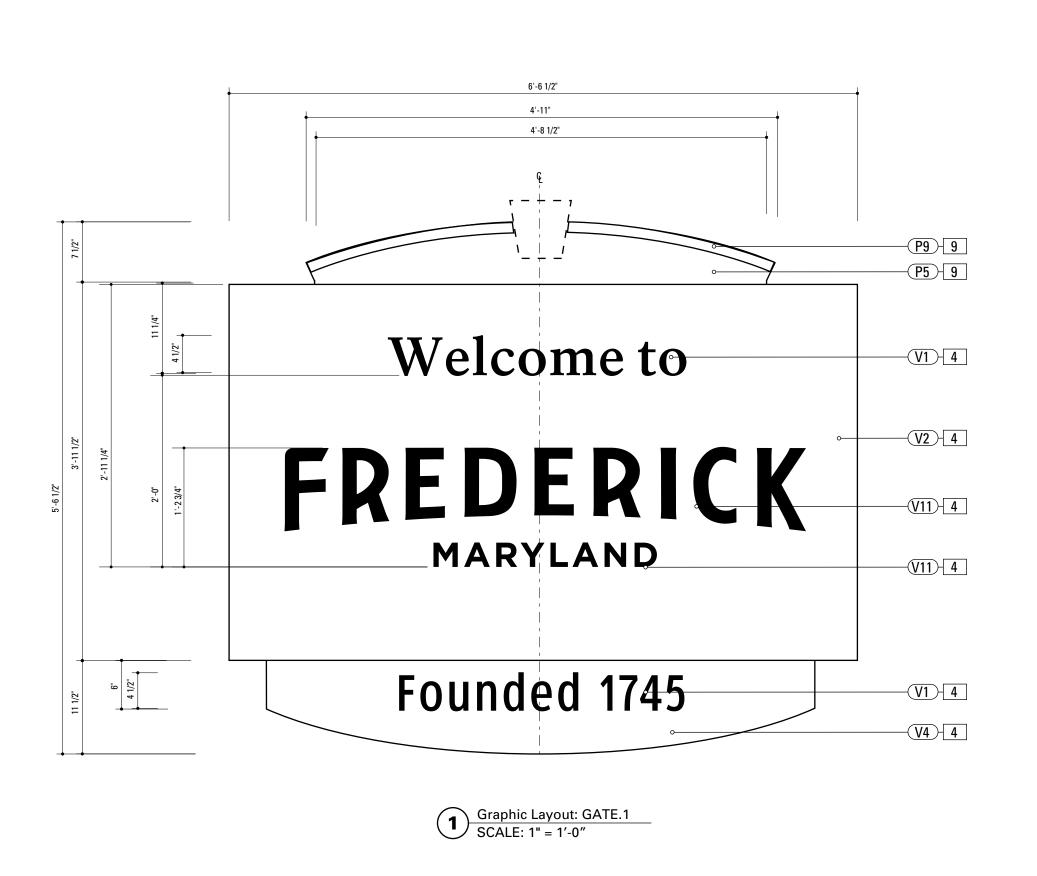

SPECIFICATIONS SIGN TYPE: GATE.1 FUNCTION:

4. SIGN PANEL

MATERIAL: 1/4" thk Aluminum
FABRICATION PROCESS: Contour Cut
EDGES: Smooth
COLOR: custom, as noted
SURFACE PROCESS: Paint all exposed surfaces
FASTENER: Continuous weld to sleeve

Vinyl Graphics applied to front face of Sign Panel. See Color Page for Specifications


9. BACKER PANEL

MATERIAL: 1/4" thk Aluminum FABRICATION PROCESS: Contour Cut EDGES: Smooth COLOR: custom, as noted SURFACE PROCESS: Paint all exposed surfaces FASTENER: Continuous weld to sleeve

Vinyl Graphics applied to front face of Sign Panel. See Color Page for Specifications

- 1. Fabricator to verify the mounting conditions and provide a detail drawing for each mounting situation, prior to fabrication. Fabricator must obtain approval from the Designer or Client for placement prior to fabrication.
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BCONSULTANT		SHEET TITLE
TE 12/17/2008	DRAWN BY: GS/KG/KB	GATE.1
se drawings are meant for DESIGN INTENT ONLY are not for construction. Contractor shall verify be responsible for all dimensions and conditions	REVISIONS	Description
ne job. Contractor shall be familiar with the site conditions it presents. This office must be noti-		SHEET NO.
of any variations from the dimensions and condi- s shown on this drawing. Shop drawings and tils must be submitted to this office for approval		SILLI NO.
r to proceeding with fabrication. All copy shall be offered by client and legal requirements checked		E.3

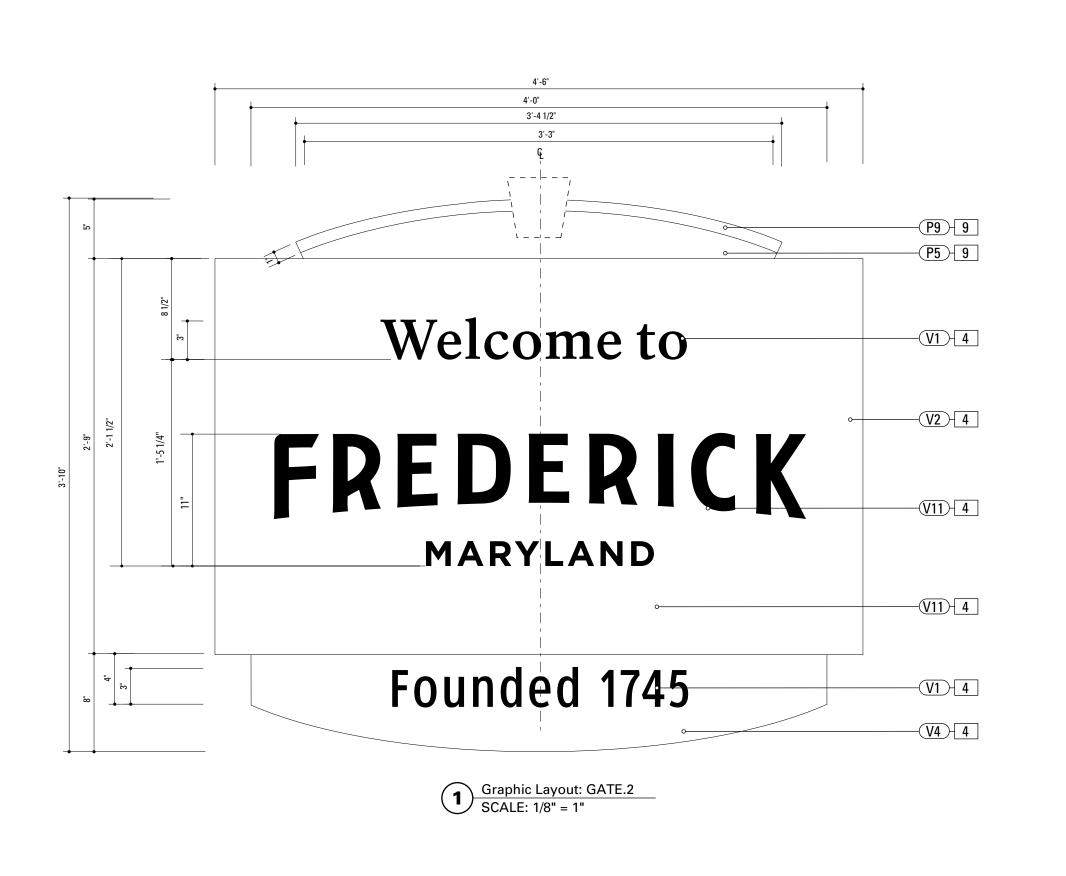

FUNCTION: City Gateway **SPECIFICATIONS SIGN TYPE:** GATE.2

4. SIGN PANEL

MATERIAL: 1/4" thk Aluminum FABRICATION PROCESS: Contour Cut EDGES: Smooth COLOR: custom, as noted SURFACE PROCESS: Paint all exposed surfaces FASTENER: Continuous weld to sleeve

Vinyl Graphics applied to front face of Sign Panel. See Color

Page for Specifications


9. BACKER PANEL

MATERIAL · 1/4" thk Aluminum FABRICATION PROCESS: Contour Cut EDGES: Smooth SURFACE PROCESS: Paint all exposed surfaces FASTENER: Continuous weld to sleeve

Vinyl Graphics applied to front face of Sign Panel. See Color Page for Specifications

- 1. Fabricator to verify the mounting conditions and provide a detail drawing for each mounting situation, prior to fabrication. Fabricator must obtain approval from the Designer or Client for placement prior to fabrication.
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JBCONSULTANT		SHEET TITLE
12/17/2008	DRAWN BY: GS/KG/KB	GATE.2
ese drawings are meant for DESIGN INTENT ONLY d are not for construction. Contractor shall verify d be responsible for all dimensions and conditions the job. Contractor shall be familiar with the site	REVISIONS	Graphic Layout
d conditions it presents. This office must be noti- d of any variations from the dimensions and condi-		SHEET NO.
ns shown on this drawing. Shop drawings and tails must be submitted to this office for approval		
or to proceeding with fabrication. All copy shall be of top of the control of the		E.4

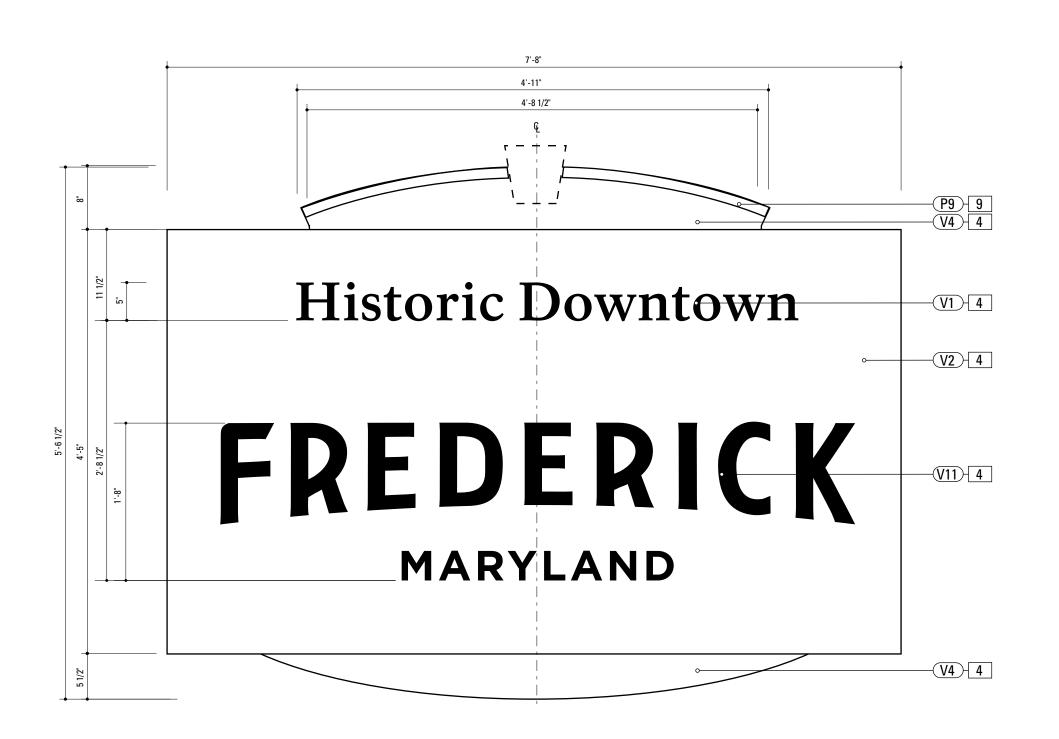

Graphic Layout: GATE.1

SCALE: 1" = 1'-0"

SPECIFICATIONS SIGN TYPE: GATE.11 FUNCTION: Downtown Gateway

4. SIGN PANEL

MATERIAL: 1/4" thk Aluminum
FABRICATION PROCESS: Contour Cut
EDGES: Smooth
COLOR: custom, as noted
SURFACE PROCESS: Paint all exposed surfaces
FASTENER: Continuous weld to sleeve

Vinyl Graphics applied to front face of Sign Panel. See Color Page for Specifications


9. BACKER PANEL

MATERIAL: 1/4" thk Aluminum FABRICATION PROCESS: Contour Cut EDGES: Smooth COLOR: custom, as noted SURFACE PROCESS: Paint all exposed surfaces FASTENER: Continuous weld to sleeve

Vinyl Graphics applied to front face of Sign Panel. See Color Page for Specifications

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	www.merjedesign.com	PROJECT NO. Y41.07961.000
BCONSULTANT		SHEET TITLE
TE 12/17/2008	DRAWN BY: GS/KG/KB	GATE.11
se drawings are meant for DESIGN INTENT ONLY are not for construction. Contractor shall verify	REVISIONS	Description
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of any variations from the dimensions and condi- s shown on this drawing. Shop drawings and		SHEET NO.
ills must be submitted to this office for approval r to proceeding with fabrication. All copy shall be offead by client and legal requirements checked		E. 5
egal denartment		

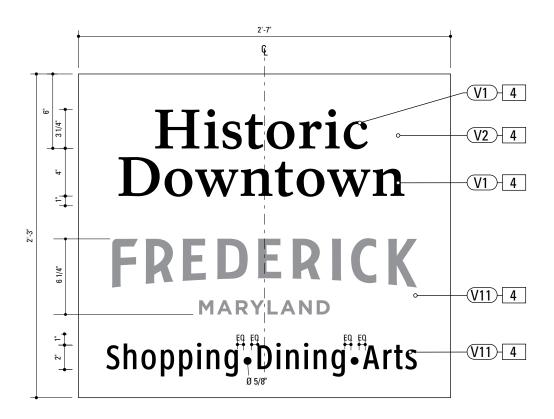

Graphic Layout: GATE.12

SCALE: 1/8" = 1"

SPECIFICATIONS SIGN TYPE: GATE.12 FUNCTION: Downtown Gateway

4. SIGN PANEL


MATERIAL: 1/4" thk Aluminum
FABRICATION PROCESS: Contour Cut
EDGES: Smooth
COLOR: custom, as noted
SURFAGE PROCESS: Paint all exposed surfaces
FASTENER: Continuous weld to sleeve

Vinyl Graphics applied to front face of Sign Panel. See Color Page for Specifications


NOTE

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	www.merjedesign.com	PROJECT NO. Y41.07961.000
UBCONSULTANT		SHEET TITLE
12/17/2008	DRAWN BY: GS/KG/KB	GATE.12
ese drawings are meant for DESIGN INTENT ONLY d are not for construction. Contractor shall verify d be responsible for all dimensions and conditions	REVISIONS	Graphic Layout
the job. Contractor shall be familiar with the site d conditions it presents. This office must be noti-		
d of any variations from the dimensions and condi- ns shown on this drawing. Shop drawings and		SHEET NO.
tails must be submitted to this office for approval ior to proceeding with fabrication. All copy shall be oofread by client and legal requirements checked		E. 6

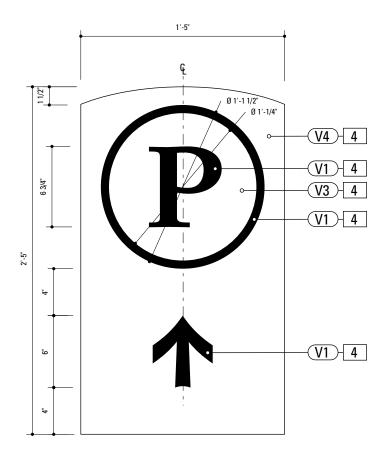

Graphic Layout: PARK.1 SCALE: 1/8" = 1"

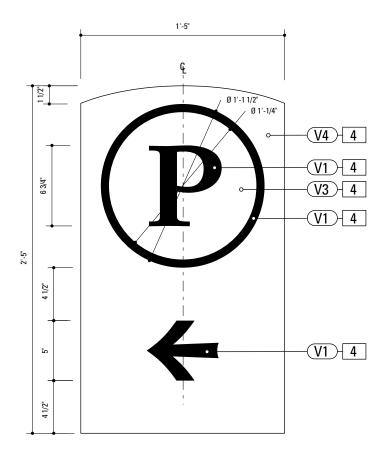

Alt. Graphic Layout: PARK.1 SCALE: 1/8" = 1"


SPECIFICATIONS SIGN TYPE: PARK.1 FUNCTION: Parking Trailblazer

4. SIGN PANEL
MATERIAL: 1/4" thk Aluminum
FABRICATION PROCESS: Contour Cut
EDGES: Smooth
COLOR: custom, as noted SURFACE PROCESS: Paint all exposed surfaces FASTENER: Continuous weld to sleeve

Vinyl Graphics applied to front face of Sign Panel. See Color Page for Specifications

- 1. Fabricator to verify the mounting conditions and provide a detail drawing for each mounting situation, prior to fabrication. Fabricator must obtain approval from the Designer or Client for placement prior to fabrication.
- 2. Welds: All welds shall be ground smooth, paint all seams.
- 3. Hardware: All exposed hardware shall be tamper proof fasteners.
- 4. All exposed edges painted to match adjacent face.

ENVIRONMENTS &	EXPERIENCES	CLIENT / PROJECT
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	www.merjedesign.com	PROJECT NO. Y41.07961.000
SUBCONSULTANT		SHEET TITLE
DATE 12/17/2008	DRAWN BY: GS/KG/KB	PARK.1
These drawings are meant for DESIGN INTENT ONLY and are not for construction. Contractor shall verify	REVISIONS	Graphic Layout
and be responsible for all dimensions and conditions of the job. Contractor shall be familiar with the site and conditions it presents. This office must be noti-		
fied of any variations from the dimensions and condi- tions shown on this drawing. Shop drawings and		SHEET NO.
details must be submitted to this office for approval prior to proceeding with fabrication. All copy shall be		E.7
proofread by client and legal requirements checked by legal department.		1

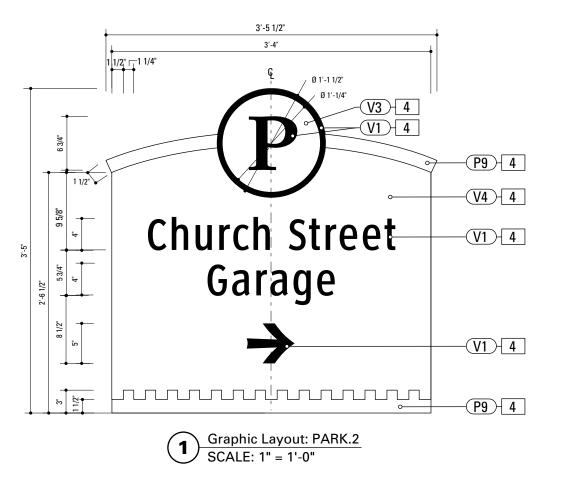

SPECIFICATIONS SIGN TYPE: PARK.2 FUNCTION:


4. SIGN PANEL

MATERIAL: 1/4" thk Aluminum
FABRICATION PROCESS: Contour Cut EDGES: Smooth COLOR: custom, as noted SURFACE PROCESS: Paint all exposed surfaces FASTENER: Continuous weld to sleeve

> Vinyl Graphics applied to front face of Sign Panel. See Color Page for Specifications

- 1. Fabricator to verify the mounting conditions and provide a detail drawing for each mounting situation, prior to fabrication. Fabricator must obtain approval from the Designer or Client for placement prior to fabrication.
- 2. Welds: All welds shall be ground smooth, paint all seams.
- 3. Hardware: All exposed hardware shall be tamper proof fasteners.
- 4. All exposed edges painted to match adjacent face.

EXPERIENCES	CLIENT / PROJECT
The Widener Building, Suite 1500 One South Penn Square Philadelphia, PA 19107 T 215.599.4407 F 215.636.9989	City of Frederick, MD Wayfinding & Signage Program
www.merjedesign.com	PROJECT NO. Y41.07961.000
	SHEET TITLE
DRAWN BY: GS/KG/KB	PARK.2
REVISIONS	Graphic Layout
]
	SHEET NO.
	F.8
	The Widener Building, Suite 1500 One South Penn Square Philadelphia, PA 19107 T 215.599.4407 F 215.636.9989 www.merjedesign.com DRAWN BY: GS/KG/KB

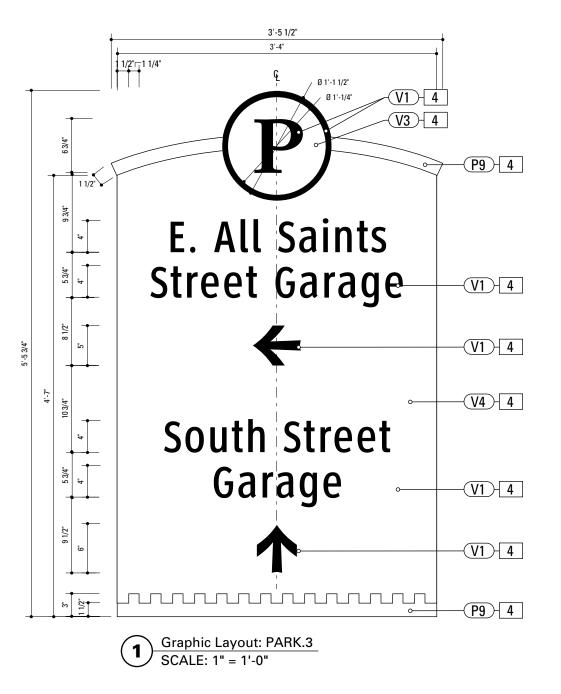

SPECIFICATIONS SIGN TYPE: PARK.3 FUNCTION: Parking Directional

4. SIGN PANEL

MATERIAL: 1/4" thk Aluminum


FABRICATION PROCESS: Contour Cut EDGES: Smooth COLOR: custom, as noted SURFACE PROCESS: Paint all exposed surfaces FASTENER: Continuous weld to sleeve

> Vinyl Graphics applied to front face of Sign Panel. See Color Page for Specifications

by legal department.

- 1. Fabricator to verify the mounting conditions and provide a detail drawing for each mounting situation, prior to fabrication. Fabricator must obtain approval from the Designer or Client for placement prior to fabrication.
- 2. Welds: All welds shall be ground smooth, paint all seams
- 3. Hardware: All exposed hardware shall be tamper proof fasteners.
- 4. All exposed edges painted to match adjacent face.

ENVIRONMENTS &	EXPERIENCES	CLIENT / PROJECT
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	www.merjedesign.com	PROJECT NO. Y41.07961.000
SUBCONSULTANT		SHEET TITLE
DATE 12/17/2008	DRAWN BY: GS/KG/KB	PARK.3
These drawings are meant for DESIGN INTENT ONLY and are not for construction. Contractor shall verify	REVISIONS	Graphic Layout
and be responsible for all dimensions and conditions of the job. Contractor shall be familiar with the site		
and conditions it presents. This office must be noti- fied of any variations from the dimensions and condi-		SHEET NO.
tions shown on this drawing. Shop drawings and details must be submitted to this office for approval prior to proceeding with fabrication. All copy shall be proofread by client and legal requirements checked		E.9

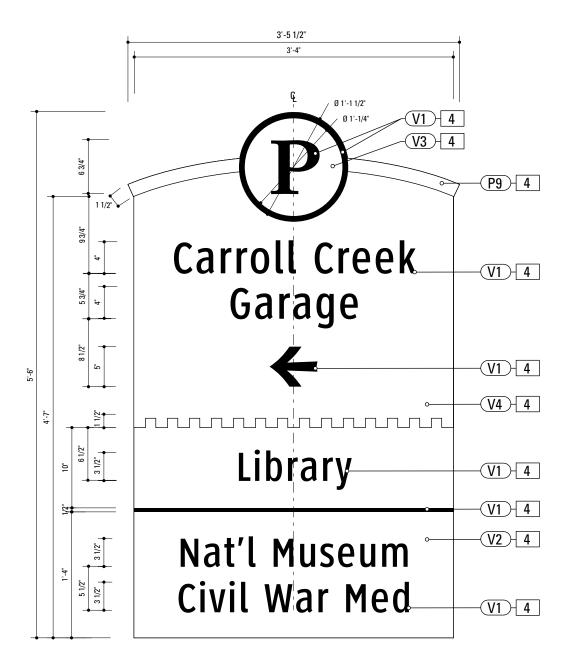

Alt. Graphic Layout: PARK.4

SCALE: 1" = 1'-0"

SPECIFICATIONS SIGN TYPE: PARK.4 FUNCTION: Parking Directional 4. SIGN PANEL MATERIAL: 1/4" thk Aluminum FABRICATION PROCESS: Contour Cut EDGES: Smooth COLOR: custom, as noted SURFACE PROCESS: Paint all exposed surfaces FASTENER: Continuous weld to sleeve Vinyl Graphics applied to front face of Sign Panel. See Color Page for Specifications 1. Fabricator to verify the mounting conditions and provide a detail drawing for each mounting situation, prior to fabrication. Fabricator must obtain approval from the Designer or Client for placement prior to fabrication. 2. Welds: All welds shall be ground smooth, paint all seams 3. Hardware: All exposed hardware shall be tamper proof fasteners. 4. All exposed edges painted to match adjacent face. CLIENT / PROJECT ENVIRONMENTS & EXPERIENCES City of Frederick, MD The Widener Building, Suite 1500 Wayfinding & Signage One South Penn Square Philadelphia, PA 19107 Program T 215.599.4407 F 215.636.9989 www.merjedesign.com PROJECT NO. Y41.07961.000 SUBCONSULTANT SHEET TITLE 12/17/2008 GS/KG/KB

These drawings are meant for DESIGN INTENT ONLY

and are not for construction. Contractor shall verify and be responsible for all dimensions and conditions of the job. Contractor shall be familiar with the site and conditions it presents. This office must be notified of any variations from the dimensions and cond tions shown on this drawing. Shop drawings and details must be submitted to this office for approval


prior to proceeding with fabrication. All copy shall be proofread by client and legal requirements checked

by legal department.

PARK.4

Parking Directional

E.10

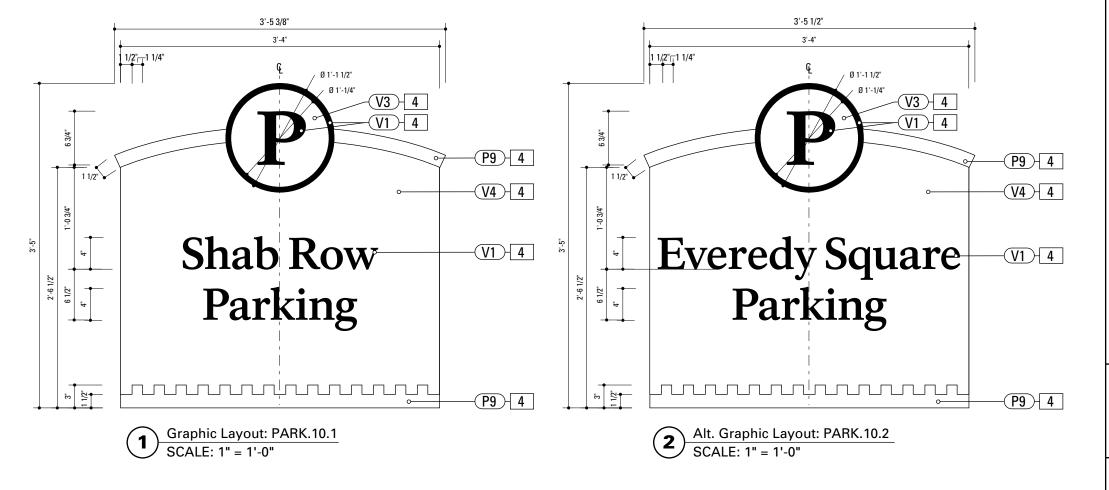

SPECIFICATIONS SIGN TYPE: PARK.10 FUNCTION: Parking Identification

4. SIGN PANEL


MATERIAL: 1/4" thk Aluminum
FABRICATION PROCESS: Contour Cut
EDGES: Smooth
COLOR: custom, as noted
SURFACE PROCESS: Paint all exposed surfaces
FASTENER: Continuous weld to sleeve


Vinyl Graphics applied to front face of Sign Panel. See Color Page for Specifications

IOTES

- Fabricator to verify the mounting conditions and provide a detail drawing for each mounting situation, prior to fabrication.
 Fabricator must obtain approval from the Designer or Client for placement prior to fabrication.
- 2. Welds: All welds shall be ground smooth, paint all seams.
- 3. Hardware: All exposed hardware shall be tamper proof fasteners.
- 4. All exposed edges painted to match adjacent face.

ENVIRONMENTS &	EXPERIENCES	CLIENT / PROJECT
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JBCONSULTANT		SHEET TITLE
12/17/2008	DRAWN BY: GS/KG/KB	PARK.10.1 -PARK.10.2
ese drawings are meant for DESIGN INTENT ONLY d are not for construction. Contractor shall verify	REVISIONS	Graphic Layout
d be responsible for all dimensions and conditions the job. Contractor shall be familiar with the site d conditions it presents. This office must be noti-		
d of any variations from the dimensions and condi- ns shown on this drawing. Shop drawings and		SHEET NO.
ails must be submitted to this office for approval or to proceeding with fabrication. All copy shall be ofread by client and legal requirements checked legal department.		E.11

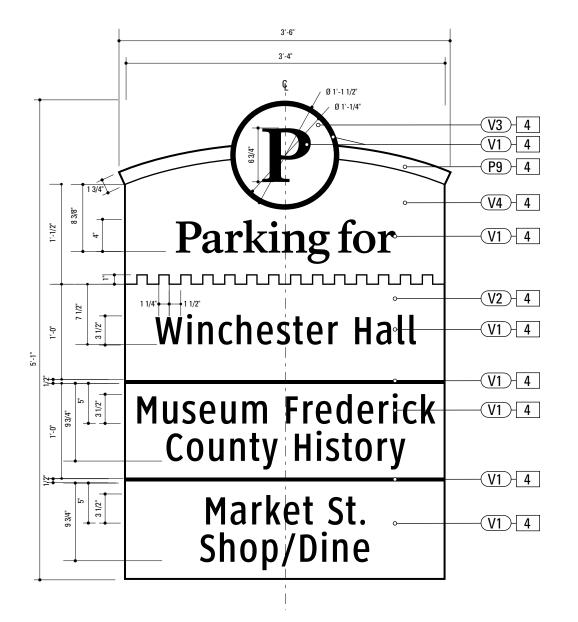

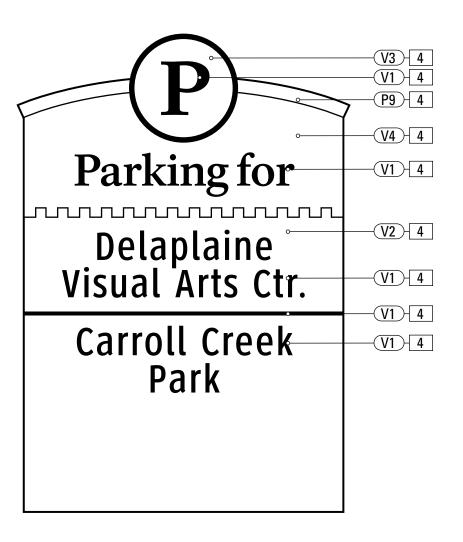

Graphic Layout: PARK.11.1
SCALE: 1" = 1'-0"

Graphic Layout: PARK.11.1
SCALE: 1" = 1'-0"

SPECIFICATIONS SIGN TYPE: PARK.11 FUNCTION: Parking ID with listing

4. SIGN PANEL

MATERIAL: 1/4" thk Aluminum FABRICATION PROCESS: Square Cut

EDGES: Smooth
COLOR: custom, as noted

SURFACE PROCESS: Paint all exposed surfaces

FASTENER: Chemically Welded to Backer Panel

BACKER PANEL

MATERIAL: 1/8" thk Aluminum

FABRICATION PROCESS: Square Cut to match dimensions of

sign panel EDGES: Smooth

COLOR: custom as noted

SURFACE PROCESS: Paint all exposed surfaces

FASTENER: mechanically fasten to existing wall. Anchor

suitable for wall material. Allowable shear capacity of anchor = 50 lbs. (min). 8 Anchors, with 1 anchor placed

at each corner. Stud Mount Welded or countersunk to sign

COPY ARROW RULE BACKGROUND

PRODUCT: 3M Engineer Grade reflective sheeting MATERIAL: vinyl FABRICATION PROCESS: Electronically cut / Applied

COLOR: custom, as noted

NOTES

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- 2. Welds: All welds shall be ground smooth, paint all seams
- 3. Hardware: All exposed hardware shall be tamper proof fasteners.
- All exposed edges painted to match adjacent face.


details must be submitted to this office for approval


prior to proceeding with fabrication. All copy shall be proofread by client and legal requirements checked


ENVIRONMENTS &	EXPERIE	NCES	CLIENT / PROJ	ECT
merje	The Widener Build One South Penn S Philadelphia, PA 19 T 215.599.4407	equare 9107 F 215.636.9989	_	of Frederick, MD inding & Signage Program
	www.merjedesign	i.com	PROJECT NO.	Y41.07961.000
SUBCONSULTANT			SHEET TITLE	
DATE 12/17/2008	DRAWN BY:	GS/KG/KB		PARK.11
These drawings are meant for DESIGN INTENT ONLY and are not for construction. Contractor shall verify	REVISIONS		Gra	phic Layout
and be responsible for all dimensions and conditions of the job. Contractor shall be familiar with the site and conditions it presents. This office must be noti-				
fied of any variations from the dimensions and condi- tions shown on this drawing. Shop drawings and			SHEET NO.	

E.12

2

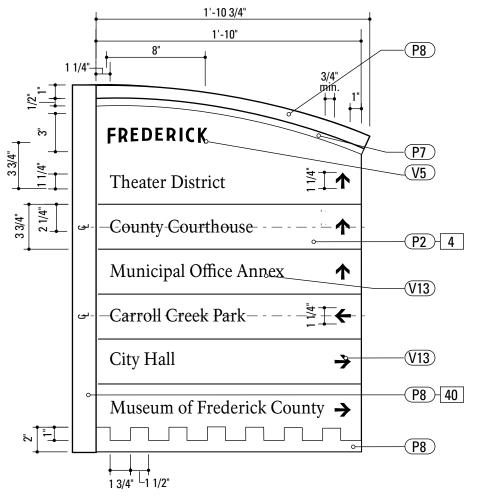

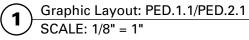

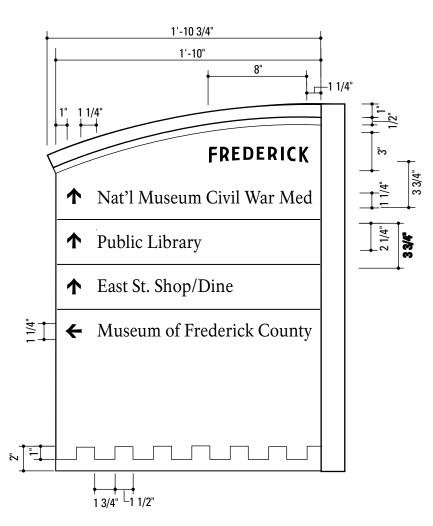

Graphic Layout: PED.1.1/PED.2.1 SCALE: 1/8" = 1"

SPECIFICATIONS SIGN TYPE: PED.1 **FUNCTION:** Pedestrian Directional

4. SIGN PANEL

MATERIAL: 1/4" thk Aluminum FABRICATION PROCESS: Contour Cut EDGES: Smooth COLOR: custom, as noted SURFACE PROCESS: Paint all exposed surfaces FASTENER: Continuous weld to sleeve

Vinyl Graphics applied to front face of Sign Panel. See Color

Page for Specifications


40. SUPPORT CHANNEL EXTRUSION


PRODUCT: Custom MATERIAL: Aluminum FABRICATION PROCESS: Extruded FINISH: Standard SURFACE PROCESS: Paint all exposed surfaces FASTENER: Mech. Fasten to Sign Panel

by legal department.

- 1. Fabricator to verify the mounting conditions and provide a detail drawing for each mounting situation, prior to fabrication. Fabricator must obtain approval from the Designer or Client for placement prior to fabrication.
- 2. Welds: All welds shall be ground smooth, paint all seams
- 3. Hardware: All exposed hardware shall be tamper proof fasteners.
- 4. All exposed edges painted to match adjacent face.

ENVIRONMENTS &	EXPERIENCES	CLIENT / PROJECT
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SUBCONSULTANT		SHEET TITLE
DATE 12/17/2008	DRAWN BY: GS/KG/KB	PED.1
These drawings are meant for DESIGN INTENT ONLY and are not for construction. Contractor shall verify	REVISIONS	Graphic Layout
and be responsible for all dimensions and conditions of the job. Contractor shall be familiar with the site		
and conditions it presents. This office must be noti- fied of any variations from the dimensions and condi-		SHEET NO.
tions shown on this drawing. Shop drawings and details must be submitted to this office for approval prior to proceeding with fabrication. All copy shall be proofread by client and legal requirements checked		E.13

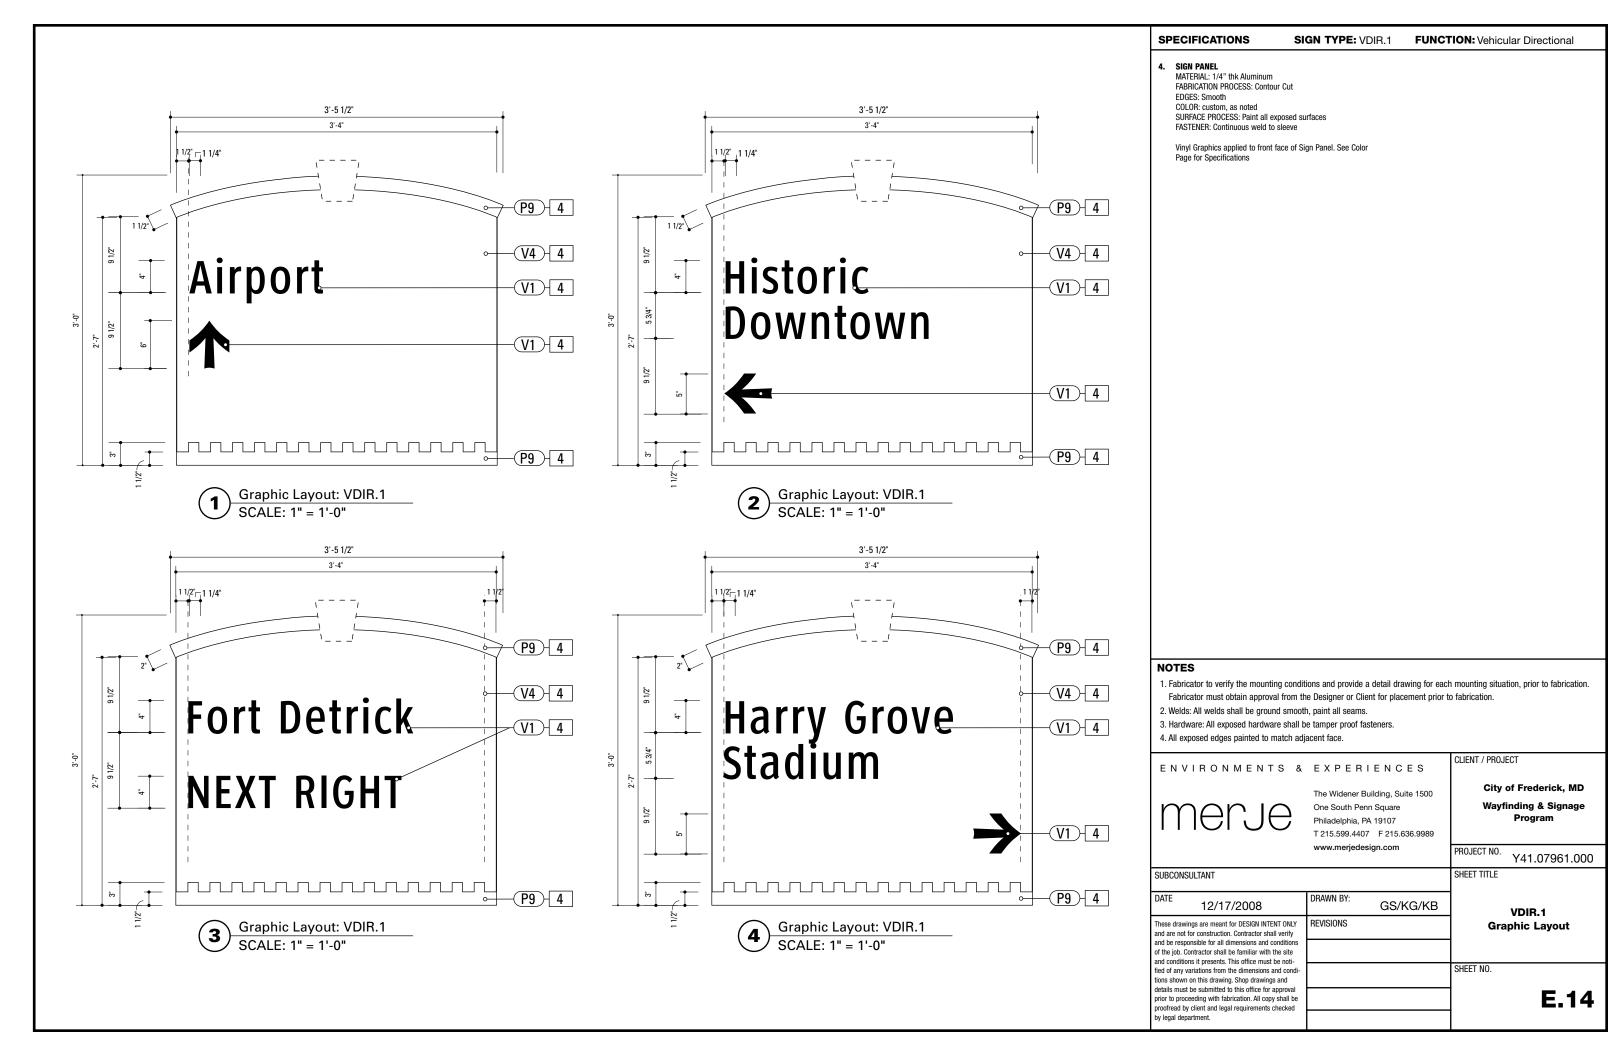

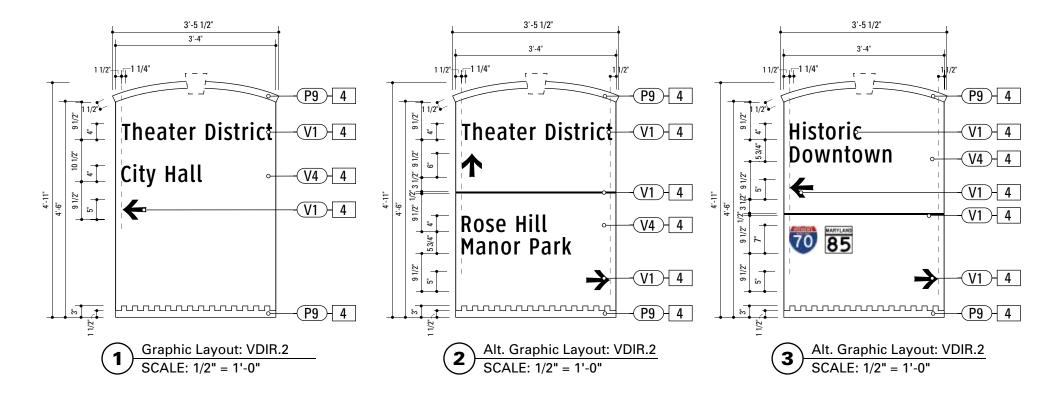

SPECIFICATIONS SIGN TYPE: VDIR.2 FUNCTION: Vehicular Directional


4. SIGN PANEL
MATERIAL: 1/4" thk Aluminum
FABRICATION PROCESS: Contour Cut
EDGES: Smooth
COLOR: custom, as noted
SURFACE PROCESS: Paint all exposed surfaces
FASTENER: Continuous weld to sleeve

Vinyl Graphics applied to front face of Sign Panel. See Color
Page for Specifications

NOTES

- Fabricator to verify the mounting conditions and provide a detail drawing for each mounting situation, prior to fabrication.
 Fabricator must obtain approval from the Designer or Client for placement prior to fabrication.
- 2. Welds: All welds shall be ground smooth, paint all seams.
- 3. Hardware: All exposed hardware shall be tamper proof fasteners.
- 4. All exposed edges painted to match adjacent face.




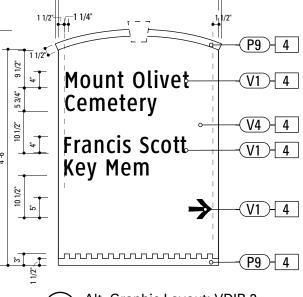

3'-5 1/2" 3'-4"


Alt. Graphic Layout: VDIR.2


SCALE: 1/2" = 1'-0"

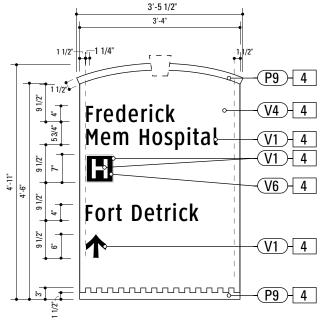

Alt. Graphic Layout: VDIR.2

SCALE: 1/2" = 1'-0"

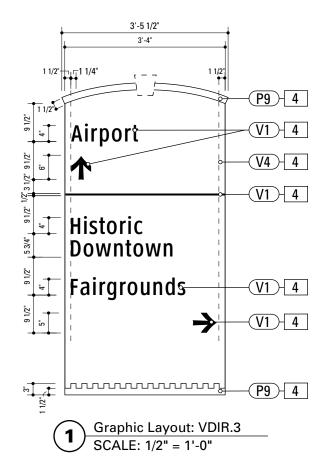

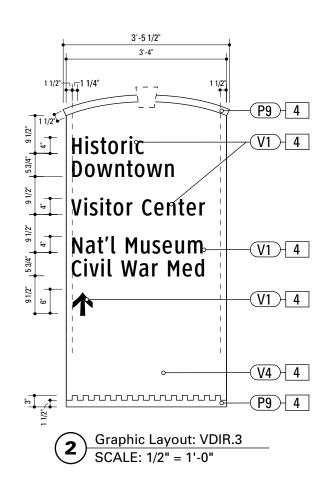


NOTES 1. Fabricator to verify the mounting conditions and provide a detail drawing for each mounting situation, prior to fabrication. Fabricator must obtain approval from the Designer or Client for placement prior to fabrication. 2. Welds: All welds shall be ground smooth, paint all seams 3. Hardware: All exposed hardware shall be tamper proof fasteners. 4. All exposed edges painted to match adjacent face. CLIENT / PROJECT ENVIRONMENTS & EXPERIENCES City of Frederick, MD The Widener Building, Suite 1500 Wayfinding & Signage One South Penn Square Program Philadelphia, PA 19107 T 215.599.4407 F 215.636.9989 www.merjedesign.com PROJECT NO. Y41.07961.000 SHEET TITLE SUBCONSULTANT DRAWN BY: 12/17/2008 GS/KG/KB VDIR.3 These drawings are meant for DESIGN INTENT ONLY REVISIONS **Graphic Layout** and are not for construction. Contractor shall verify and be responsible for all dimensions and condition of the job. Contractor shall be familiar with the site and conditions it presents. This office must be noti-SHEET NO. fied of any variations from the dimensions and cond tions shown on this drawing. Shop drawings and details must be submitted to this office for approval **E.16** prior to proceeding with fabrication. All copy shall be proofread by client and legal requirements checked by legal department.

SPECIFICATIONS

SIGN TYPE: VDIR.3

FUNCTION: Vehicular Directional

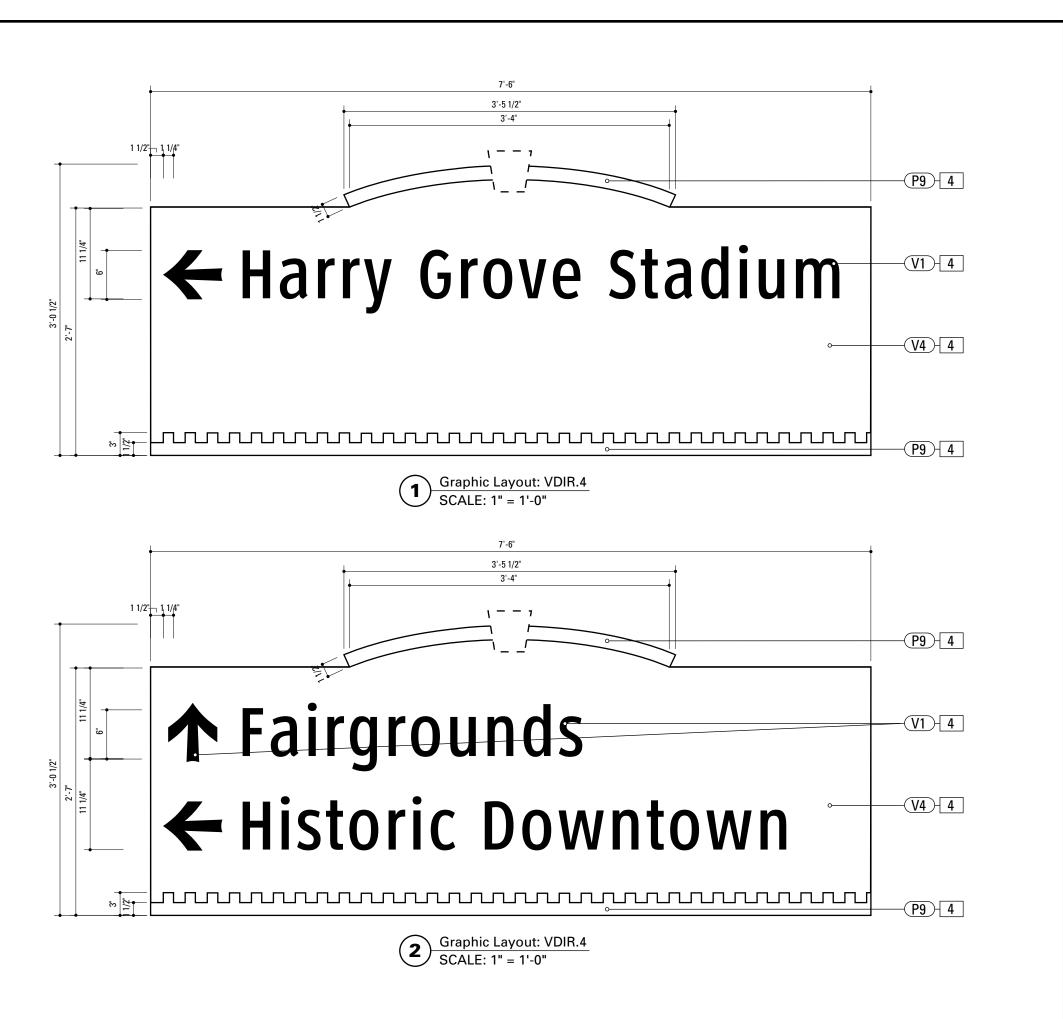

SPECIFICATIONS SIGN TYPE: VDIR.4 FUNCTION: Vehicular Directional

4. SIGN PANEL

MATERIAL: 1/4" thk Aluminum FABRICATION PROCESS: Contour Cut EDGES: Smooth COLOR: custom, as noted SURFACE PROCESS: Paint all exposed surfaces FASTENER: Continuous weld to sleeve

Vinyl Graphics applied to front face of Sign Panel. See Color

Page for Specifications

- Fabricator to verify the mounting conditions and provide a detail drawing for each mounting situation, prior to fabrication.
 Fabricator must obtain approval from the Designer or Client for placement prior to fabrication.
- 2. Welds: All welds shall be ground smooth, paint all seams
- 3. Hardware: All exposed hardware shall be tamper proof fasteners.
- 4. All exposed edges painted to match adjacent face.





Graphic Layout: VDIR.5
SCALE: 1" = 1'-0"

SPECIFICATIONS SIGN TYPE: VDIR.5 FUNCTION: Vehicular Directional

4. SIGN PANEL

MATERIAL: 1/4" thk Aluminum
FABRICATION PROCESS: Contour Cut
EDGES: Smooth
COLOR: custom, as noted
SURFACE PROCESS: Paint all exposed surfaces
FASTENER: Continuous weld to sleeve

Vinyl Graphics applied to front face of Sign Panel. See Color Page for Specifications

NOTE

- Fabricator to verify the mounting conditions and provide a detail drawing for each mounting situation, prior to fabrication.
 Fabricator must obtain approval from the Designer or Client for placement prior to fabrication.
- 2. Welds: All welds shall be ground smooth, paint all seams
- Hardware: All exposed hardware shall be tamper proof fasteners.
- 4. All exposed edges painted to match adjacent face.

details must be submitted to this office for approval


prior to proceeding with fabrication. All copy shall be proofread by client and legal requirements checked

by legal department.

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UBCONSULTANT		SHEET TITLE
ATE 12/17/2008	DRAWN BY: GS/KG/KB	VDIR.5
nese drawings are meant for DESIGN INTENT ONLY and are not for construction. Contractor shall verify	REVISIONS	Vehicular Directional
nd be responsible for all dimensions and conditions the job. Contractor shall be familiar with the site and conditions it presents. This office must be noti-		
ed of any variations from the dimensions and condi-		SHEET NO.

E.18

F. Construction Details

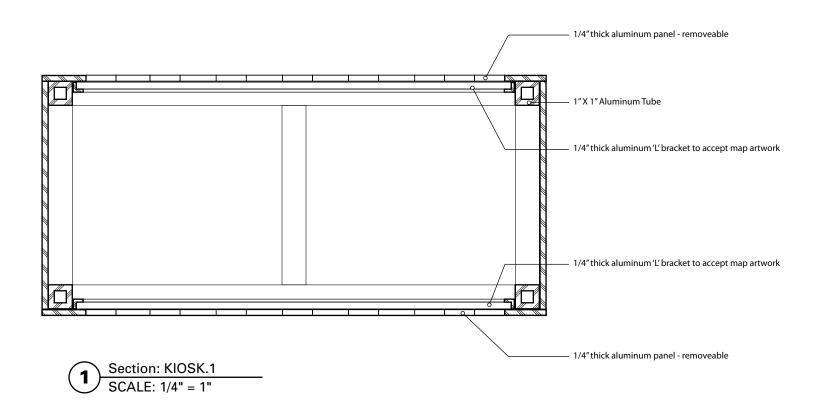

2. Welds: All welds shall be ground smooth, paint all seams. 3. Hardware: All exposed hardware shall be tamper proof fasteners. 4. All exposed edges painted to match adjacent face. CLIENT / PROJECT ENVIRONMENTS & EXPERIENCES City of Frederick, MD The Widener Building, Suite 1500 Wayfinding & Signage One South Penn Square Program Philadelphia, PA 19107 T 215.599.4407 F 215.636.9989 www.merjedesign.com PROJECT NO. Y41.07961.000 SHEET TITLE SUBCONSULTANT DRAWN BY: 12/17/2008 GS/KG/KB KIOSK.1 REVISIONS These drawings are meant for DESIGN INTENT ONLY Section and are not for construction. Contractor shall verify and be responsible for all dimensions and conditions of the job. Contractor shall be familiar with the site and conditions it presents. This office must be noti-fied of any variations from the dimensions and condi-SHEET NO. tions shown on this drawing. Shop drawings and details must be submitted to this office for approval

F.1

1. Fabricator to verify the mounting conditions and provide a detail drawing for each mounting situation, prior to fabrication.

Fabricator must obtain approval from the Designer or Client for placement prior to fabrication.


SIGN TYPE: KIOSK.1 **FUNCTION:** Pedestrian Kiosk

SPECIFICATIONS

NOTES

prior to proceeding with fabrication. All copy shall be proofread by client and legal requirements checked

by legal department.

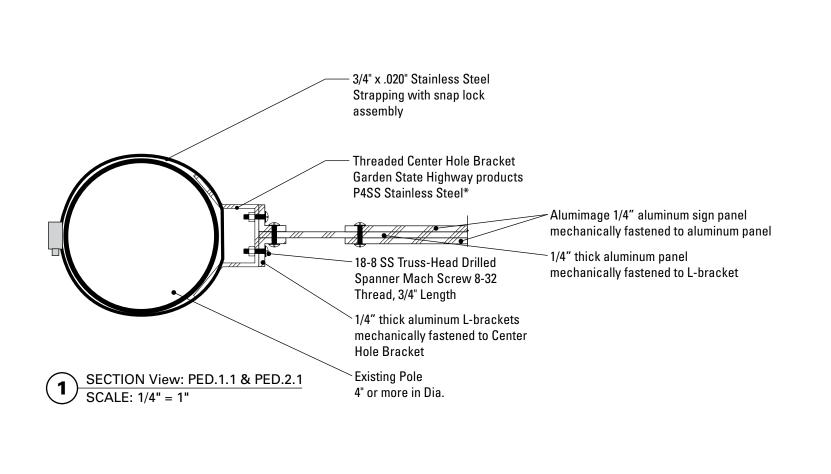

NOTES

SPECIFICATIONS

SIGN TYPE: PED.1

FUNCTION: Pedestrian Directional


- Fabricator to verify the mounting conditions and provide a detail drawing for each mounting situation, prior to fabrication.
 Fabricator must obtain approval from the Designer or Client for placement prior to fabrication.
- 2. Welds: All welds shall be ground smooth, paint all seams.
- 3. Hardware: All exposed hardware shall be tamper proof fasteners.
- 4. All exposed edges painted to match adjacent face.

ENVIRONMENTS &	EXPERIENCES	CLIENT / PROJECT
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	www.merjedesign.com	PROJECT NO. Y41.07961.000
SUBCONSULTANT		SHEET TITLE
		4
DATE 12/17/2008	DRAWN BY: GS/KG/KB	PED.1
DATE 12/17/2008 These drawings are meant for DESIGN INTENT ONLY and are not for construction. Contractor shall verify and be responsible for all dimensions and conditions of the job. Contractor shall be familiar with the site and conditions it presents. This office must be noti-	DRAWN BY: GS/KG/KB REVISIONS	PED.1 Section


Lip-Lok Bolt Assembly

SX0121

- Shape of head provides maximum contact with inside of channel extrusion for superior holding power.
- Stainless Steel, M8 Metric Thread.
- Includes nut and washer.

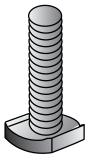


Universal Channel Clamp

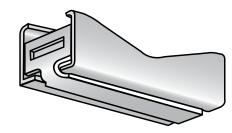

SX0220


• Compatible with all SIGNFIX Channel extrusions.


 During installation, the assembly becomes fully adjustable to any size or style sign post when used with BAND-IT Band and Buckle or Ultra-Lok Free End System.

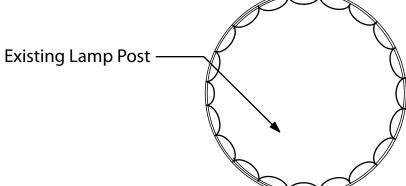


Support Channel Extrusions

For mounting and stiffening any size sign.

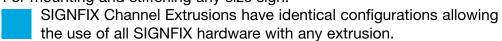


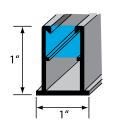


SX0073 Medium Channel Extrusion 10' Stock Length

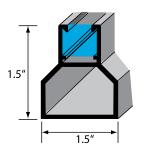

SX0130 Large Channel Extrusion 10' Stock Length

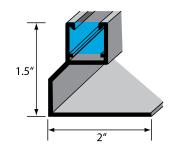

SX0090 Large Corner Angle Channel Extrusion 10' Stock Length

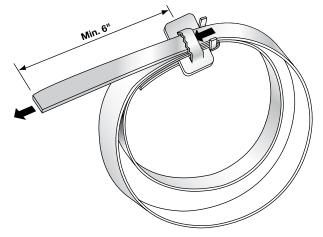

NOTE

SPECIFICATIONS

1. Fabricator to verify the mounting conditions and provide a detail drawing for each mounting situation, prior to fabrication. Fabricator must obtain approval from the Designer or Client for placement prior to fabrication.

SIGN TYPE: PARK.1-2 **FUNCTION:** Parking Directional

- 2. Welds: All welds shall be ground smooth, paint all seams.
- 3. Hardware: All exposed hardware shall be tamper proof fasteners.
- 4. All exposed edges painted to match adjacent face.


ENVIRONMENTS &	EXPERIENCES	CLIENT / PROJECT
merje	The Widener Building, Suite 1500 One South Penn Square Philadelphia, PA 19107 T 215.599.4407 F 215.636.9989	City of Frederick, MD Wayfinding & Signage Program
	www.merjedesign.com	PROJECT NO. Y41.07961.00
SUBCONSULTANT		SHEET TITLE
DATE 12/17/2008	DRAWN BY: GS/KG/KB	PARK.1, PARK.2
These drawings are meant for DESIGN INTENT ONLY and are not for construction. Contractor shall verify and be responsible for all dimensions and conditions of the job. Contractor shall be familiar with the site and conditions it presents. This office must be noti-	REVISIONS	Mounting Detail
fied of any variations from the dimensions and condi- tions shown on this drawing. Shop drawings and details must be submitted to this office for approval		SHEET NO.
prior to proceeding with fabrication. All copy shall be proofread by client and legal requirements checked		j fik



Mounting Detail Section View: PARK.1/2


SCALE: 1/2" = 1"

G. Footer Details

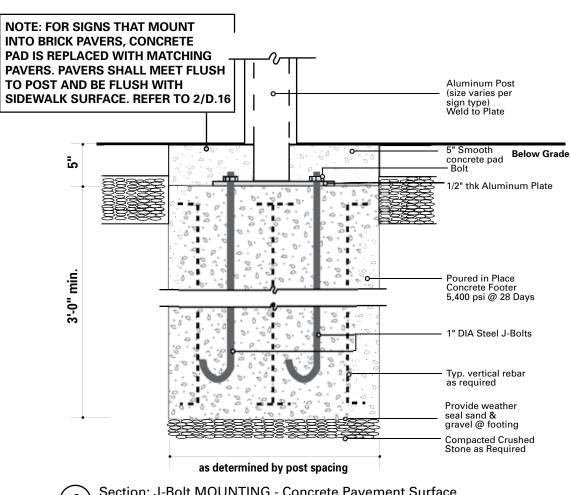

Section: J-Bolt MOUNTING - Concrete Pavement Surface

SCALE: 1" = 1' - 0"

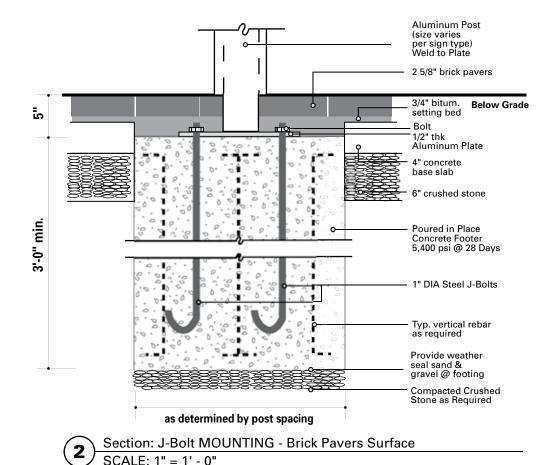

as determined by post spacing

1'-0" typ.

Plan View of Footer Detail

SCALE: 1/8" = 1"

Smooth concrete pad with color additive to match existing adjacent concrete

SPECIFICATIONS

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Where a basement/vault interferes with a proposed location. The sign shall be relocated to a location deemed appropriate by the City of Frederick Department of Public Works

Where relocation is not an option the FABRICATOR will develop the appropriate mounting solution. The solution shall meet all engineering criteria as established by the standard footings. (i.e. windloads)

FINAL DESIGNS AND SHOP DRAWINGS SHALL BE SUPPLIED BY THE FABRICATOR FOR EACH OF THE BREAK-AWAY POLES IDENTIFIED AND A MARYLAND REGISTERED PROFESSIONAL ENGINEER IS REQUIRED TO SIGN AND SEAL THE SUBMITTAL OF SHOP DRAWINGS.

NOTE:

- 1) SOIL IS AVERAGE WITH MAXIMUM ALLOWABLE SOIL PRESSURE OF 3,000 POUNDS PER SQUARE FOOT. SOIL UNIT WEIGHT OF 125 PCF AND FRICTION ANGLE OF 30 DEGREES (ASSUMED).
- 2) CONCRETE STRENGTH AT 28 DAYS F'C=4,000 PSI REINFORCEMENT SHALL BE ASTM 36 FY=60,000 PSI
- 3) FOLLOW 2008 MDOT DESIGN STANDARDS FOR MATERIAL AND CONSTRUCTION INFORMATION FOR THE SIGN POST BASES AND FOUNDATIONS NOT OTHERWISE SPECIFIED IN THESE CONTRACT DRAWINGS
- 4) FOR SIGN POST SIZES REFER TO THE DESIGN INTENT DRAWING SHEETS

- 1. Fabricator to verify the mounting conditions and provide a detail drawing for each mounting situation, prior to fabrication. Fabricator must obtain approval from the Designer or Client for placement prior to fabrication.
- 2. Welds: All welds shall be ground smooth, paint all seams
- 3. Hardware: All exposed hardware shall be tamper proof fasteners.
- 4. All exposed edges painted to match adjacent face.

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www.merjedesign.com	PROJECT NO. Y41.07961.000	
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Outside Diameter Special Bolt 0 Bracket Bracket Coupling **Anchor**


BREAK-SAFE MODEL AP BREAKAWAY ASSEMBLY

SCALE: NTS


BREAK-SAFE MODEL AP ANCHOR SPACING

BREAK-SAFE MODEL	O.D POLE (D)	NOMINAL SCH. 40 PIPE SIZE	(A)	(B)
AP3	3" (76 mm)	_	2 3/4" (70mm)	7 15/16" (202 mm)
AP3.5	3 1/2" (89 mm)	3" (76 mm)	2 3/4" (70mm)	7 15/16" (202 mm)
AP4	4" (102 mm)	3 1/2" (89 mm)	3 1/4" (83mm)	8 15/16" (227 mm)
AP4.5	4 1/2" (114 mm)	4" (102 mm)	3 1/4" (83mm)	8 15/16" (227 mm)


NOTE: For Poles greater than 4 1/2" use Pole-Safe 5100 Series

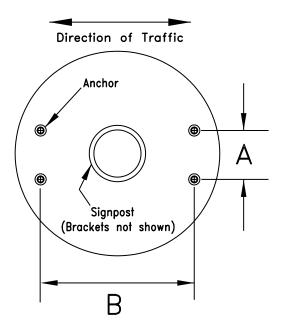

PLAN VIEW OF TYPICAL FOUNDATION SCALE: NTS

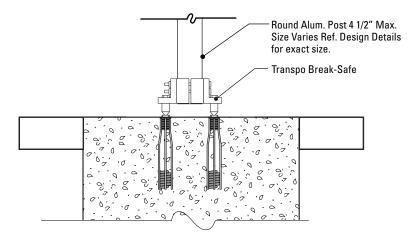

NOTE: SEE DWG. K.4 FOR FOUNDATION DETAILS

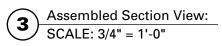

SPECIFICATIONS

BREAK-SAFE Model AP as manufactured by TRANSPO Industries, Inc. 20 Jones Street New Rochelle, NY 10801 914-636-1000 www.transpo.com

Break-Safe meets all requirements of "AASHTO Standard Specifications for Structural Supports for Highway Signs, Luminaries, and Traffic Signals."

Break-Safe Model AP is designed to fit steel or aluminum round pipe signposts. See Table for pipe sizes. For larger pole diameters, use Pole-Safe as manufactured by TRANSPO Industries, Inc.

All Hardware items are American Standard sizes, galvanized in accordance with ASTM A153 (hot dipped) or ASTM B695 (mechanically applied).


Fasteners, except for special bolt and coupling, are installed with lockwashers, and do not have specific torque requirements. Fasteners should be secured as tight as possible with conventional wrenches, unless otherwise noted.


Square-up and level individual components, particularly Anchors to minimize the need for shimming between Couplings and Anchors.


No more than two shims shall be placed under any one coupling. No more than three shims underneath any pair of couplings.

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- ${\it 3. \ Hardware: All \ exposed \ hardware \ shall \ be \ tamper \ proof \ fasteners.}$
- 4. All exposed edges painted to match adjacent face.

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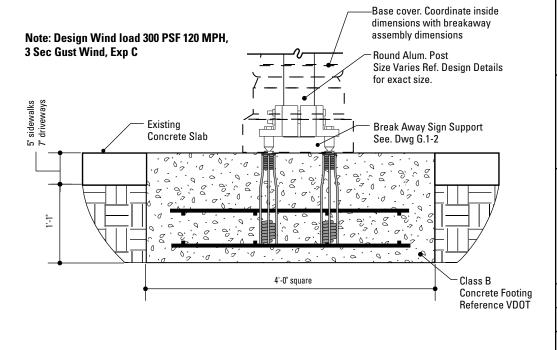


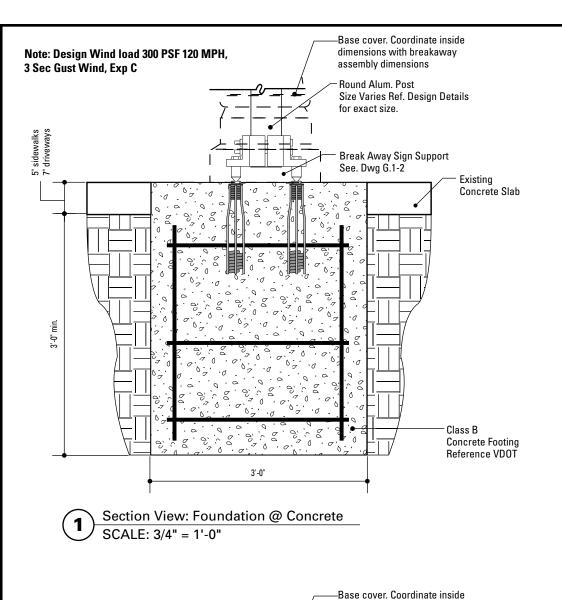

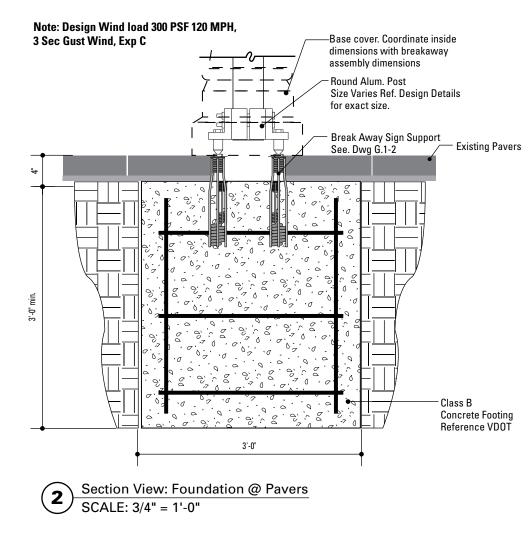

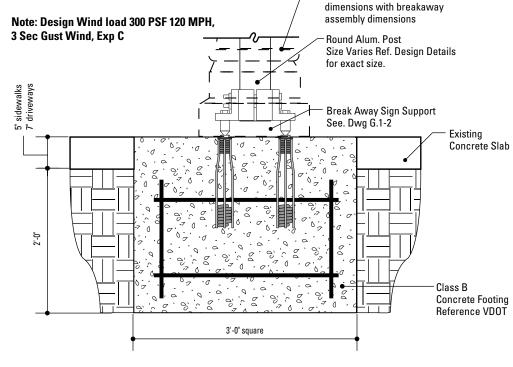Section View: Foundation: Shallow Depth

SCALE: 3/4" = 1'-0"



Section View: Foundation: Extremely Shallow Depth SCALE: 3/4" = 1'-0"

SPECIFICATIONS

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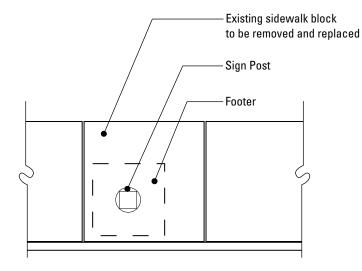
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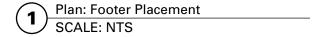
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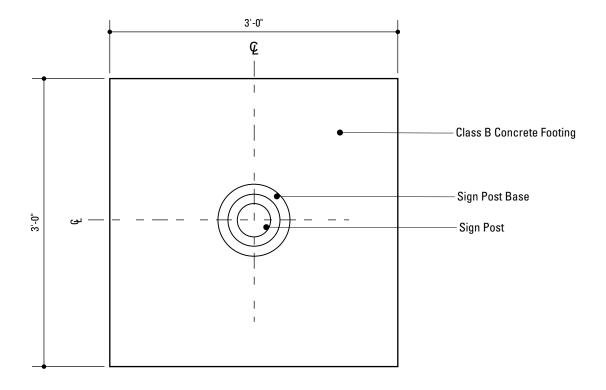
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NOTE: When locating a footer within a single pavement block (max. 5'-0" x 5'-0"), adjacent to at least 2 expansion joints, the entire block of pavement shall be removed and replaced with the same materials and finish of adjacent sidewalk areas.





Plan View: Footer
SCALE: 1" = 1' - 0"

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